elephone Number

THE MARYLAND NATIONAL CAPITAL PARK AND PLANNING COMMISION OVID HAZEN WELLS PARK

FACILITY PLAN

12001 SKYLARK ROAD, CLARKSBURG, MD 20871

LEGEND

PROPERTY LINE EXISTING CONTOUR TREE PROTECTION FENCE LIMITS OF DESTURBANCE PROPOSED WALL PROPOSED CONTOUR PROPOSED SPOT ELEVATION

EXISTING TREE PROPOSED CONCRETE

PROPOSED SCORED CONCRETE PROPOSED ASPHALT PAVEMENT

PROPOSED ASPHALT PATH PROPOSED WATER FEATURE

EXISTING HOUSE

FOREST TREELINE

STREAM

STREAM BUFFER

WETLANDS _____ NTW _____ NTW ____ 40'-100' WETLANDS BUFFER —— WB ——— WB —— EXISTING SANITARY SEWER ___*X"S*___ EXISTING STORM DRAIN

EXISTING UTILITY POLE EXISTING OVHD UTILITY LINE EXISTING U/G ELECTRIC LINE EXISTING FIRE HYDRANT EXISTING WATER METER EXISTING LIGHT

EXISTING SIGN EXISTING CHAIN LINK FENCE EXISTING BUILDING TO BE REMOVED

EXISTING CONCRETE AND EX. CONCRETE SIDEWALK TO BE REMOVED

EXISTING ASPHALT PAVEMENT TO BE REMOVED FEATURE TO BE REMOVED

2. DETERMINE THE EXACT LOCATION OF ALL EXISTING UTILITIES BEFORE COMMENCING

— ОНИ—

— E —

3. SUBSTITUTIONS IN PRODUCTS AND MATERIALS SHALL NOT BE MADE WITHOUT PRIOR APPROVAL BY THE PARK DEVELOPMENT DIVISION'S PROJECT MANAGER OR

1. THE PROPOSED PLANS ARE BASED ON THE SURVEY WITH AVAILABLE DATA.

GENERAL NOTES

ALL UTILITIES.

4. THE INSTALLER IS RESPONSIBLE FOR KEEPING ALL WORK AND RELATED ACTIVITIES WITHIN THE DESIGNATED LIMIT OF WORK. PORTIONS OF EACH PARK SHALL REMAIN IN

5. INSTALL TREE PROTECTION AND EROSION CONTROL MEASURES PRIOR TO THE START AND CONSTRUCTION IS COMPLETE.


6. THE INSTALLER SHALL KEEP VEHICULAR ACCESS AREAS, DRIVEWAYS, AND OTHER PAVED AREAS CLEAN AND FREE OF MUD ON A DAILY BASIS DURING CONSTRUCTION.

STOCKPILES IN SUCH A MANNER AS TO PROTECT EXISTING CONDITIONS, SUCH AS UTILITIES, VEGETATION, ETC. PROTECT ALL EXISTING CONDITIONS UNLESS OTHERWISE NOTED. DO NOT STOCKPILE SOIL OR CONSTRUCTION MATERIALS, OR DRIVE VEHICLES WITHIN THE CRITICAL ROOT ZONES OF EXISTING TREES TO REMAIN. COORDINATE ALL CONSTRUCTION ACCESS AREA. STAGING AND STOCKPILE AREAS WITH THE CONSTRUCTION MANAGER (JAY CHILDS, 301-495-2574).

8. PROMPTLY NOTIFY THE PARK DEVELOPMENT DIVISION'S CONSTRUCTION MANAGER OF ANY UNEXPECTED SUBSURFACE CONDITIONS DURING THE COURSE OF WORK THAT WOULD REQUIRE CHANGES TO THE DESIGN.

9. PROMPTLY REPAIR ALL DAMAGE CAUSED BY CONSTRUCTION OPERATIONS TO EXISTING PAVEMENT, DRIVEWAYS, AND OTHER FACILITIES TO THE SATISFACTION OF THE CONSTRUCTION MANAGER. SPREAD TOPSOIL AND RE-ESTABLISH LAWN AREAS AS NECESSARY TO THE SATISFACTION OF THE CONSTRUCTION MANAGER.

10. UPON COMPLETION OF THE PROJECT, THE INSTALLER SHALL REMOVE FROM THE SITE ALL EXCESS SOIL, STONE, TEMPORARY FENCING, MULCH, AND ALL OTHER DEBRIS AND MATERIALS AND SHALL DISPOSE OF THESE MATERIALS OFF SITE LEGALLY. ALL PAVED AREAS, CURBS, ETC. SHALL BE THOROUGHLY WASHED AND CLEANED UPON COMPLETION OF THE PROJECT.

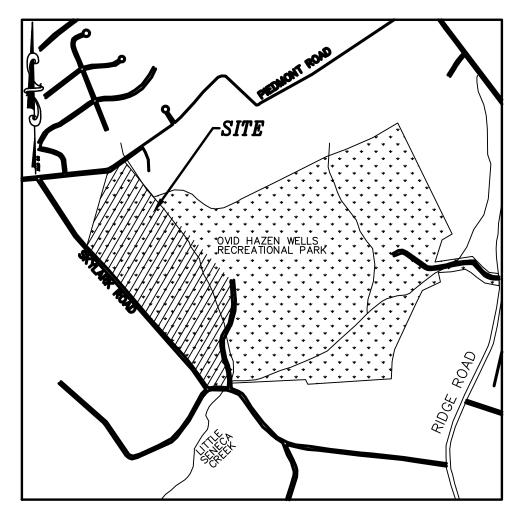

		SHEET INDEX
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1	L-1.1	Title Sheet
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3	L-1.3	Overall Existing/Demotion Plan
4	L-2.1A	Overall Site Plan
4	L-2.1	Sheet Layout
5	L-2.2	Site Plan
6	L-2.3	Site Plan
7	L-2.4	Site Plan
8	L-2.5	Site Plan
9	L-2.6	Phase I Alternative Site Plan
10	L-3.1	Overall Landscape Plan
11	L-4.1	Overall Forest Conservation Plan
12	SWM-1	Overall SWM Concept Plan
13	SWM-2	SWM Concept Plan
14	SWM-3	SWM Concept Plan
15	SWM-4	SWM Concept Plan
16	SWM-5	SWM Concept Plan
17	SWM-6	SWM Concept Plan
18	SWM-7	SWM Details
19	ESC-1	Overall Erosion & Sediment Control Plan
20	ESC-2	Erosion and Sediment Control Plan
21	ESC-3	Erosion and Sediment Control Plan
22	ESC-4	Erosion and Sediment Control Plan
23	ESC-5	Erosion and Sediment Control Plan
24	ESC-6	Erosion and Sediment Control Plan
25	ESC-7	Erosion and Sediment Control Details

UTIL	ITY SURVEY &	RELOCATION	ON CERTIFIC	ATION
UTILITY	DATE REQUESTED	DATE RECEIVED	SHOWN ON PLANS	RELOCATION REQ'D
PEPCO	N/A			
WSSC	N/A			
AT&T	NA			
WG&L	N/A			
VERIZON	N/A			
COMCAST	NA			
TY STATEME	N=		5	

MISS UTILITY

CALL "MISS UTILITY AT 8-1-1 OR 1-800-257-7777 OR LOG ON TO www.call811.com or www.missutility.net 48 HOURS IN ADVANCE OF ANY WORK IN THIS VICINITY. THE EXCAVATOR MUST NOTIFY ALL PUBLIC UTILITY COMPANIES WITH UNDERGROUND FACILITIES IN THE AREA OF PROPOSED EXCAVATION AND HAVE THOSE FACILITIES LOCATED BY THE UTILITY COMPANIES PRIOR TO COMMENCING EXCAVATION. BEFORE EXCAVATION THE CONTRACTOR IS RESPONSIBLE FOR CALLING TICKET CHECK AT 1-866-821-4226 TO VERIFY THAT ALL UTILITIES HAVE BEEN MARKED, 48 HOURS AFTER CALLING MISS UTILITY.

ADA COMPLPLIANCE CERTIFICATION The design of this project has incorporated facilities for the

elderly and handicapped in compliance with the County, State

UT-1

Utility Plan

Design Engineer

and Federal Legislation.

APPROVED FOR PROCUREMENT


Approved By: Michael Ma Acting Chief, Parks Development Division

OWNER/DEVELOPER/APPLICANT: THE MARYLAND-NATIONAL CAPITAL PARK AND PLANNING COMMISSION MONTGOMERY COUNTY DEPARTMENT OF PARKS 9500 BRUNETT AVENUE SILVER SPRING, MARYLAND 20901 ATTN: KIMBERLY PANIATI PHONE: 301.495.2465

kimberly.paniati@montgomeryparks.org

		DESIGN	
Designer's Name	Landscape Ar Date	chitect Checked By:	
Address	Architect Date	Checked By:	
 City/State/Zip	Engineer Date	Checked By:	
	Drawn by Date	Checked By:	

NORTON LAND DESIGN LANDSCAPE ARCHITECTURE + ENVIRONMENTAL PLANNING 17830 NEW HAMPSHIRE AVENUE, SUITE 101 ASHTON, MD 20861 P.240.342.2329 F.240.342.2632 WWW.NORTONLANDDESIGN.COM

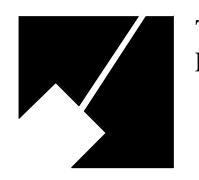

The Maryland-National Capital Park and Planning Commission

Montgomery County Department of Parks 9500 Brunett Avenue Silver Spring, Maryland 20901 (301) 495-2535


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	Rev. No.	Date	Description		
Project Manager Date					
Construction Manager Date					
Park Manager Date				SC	


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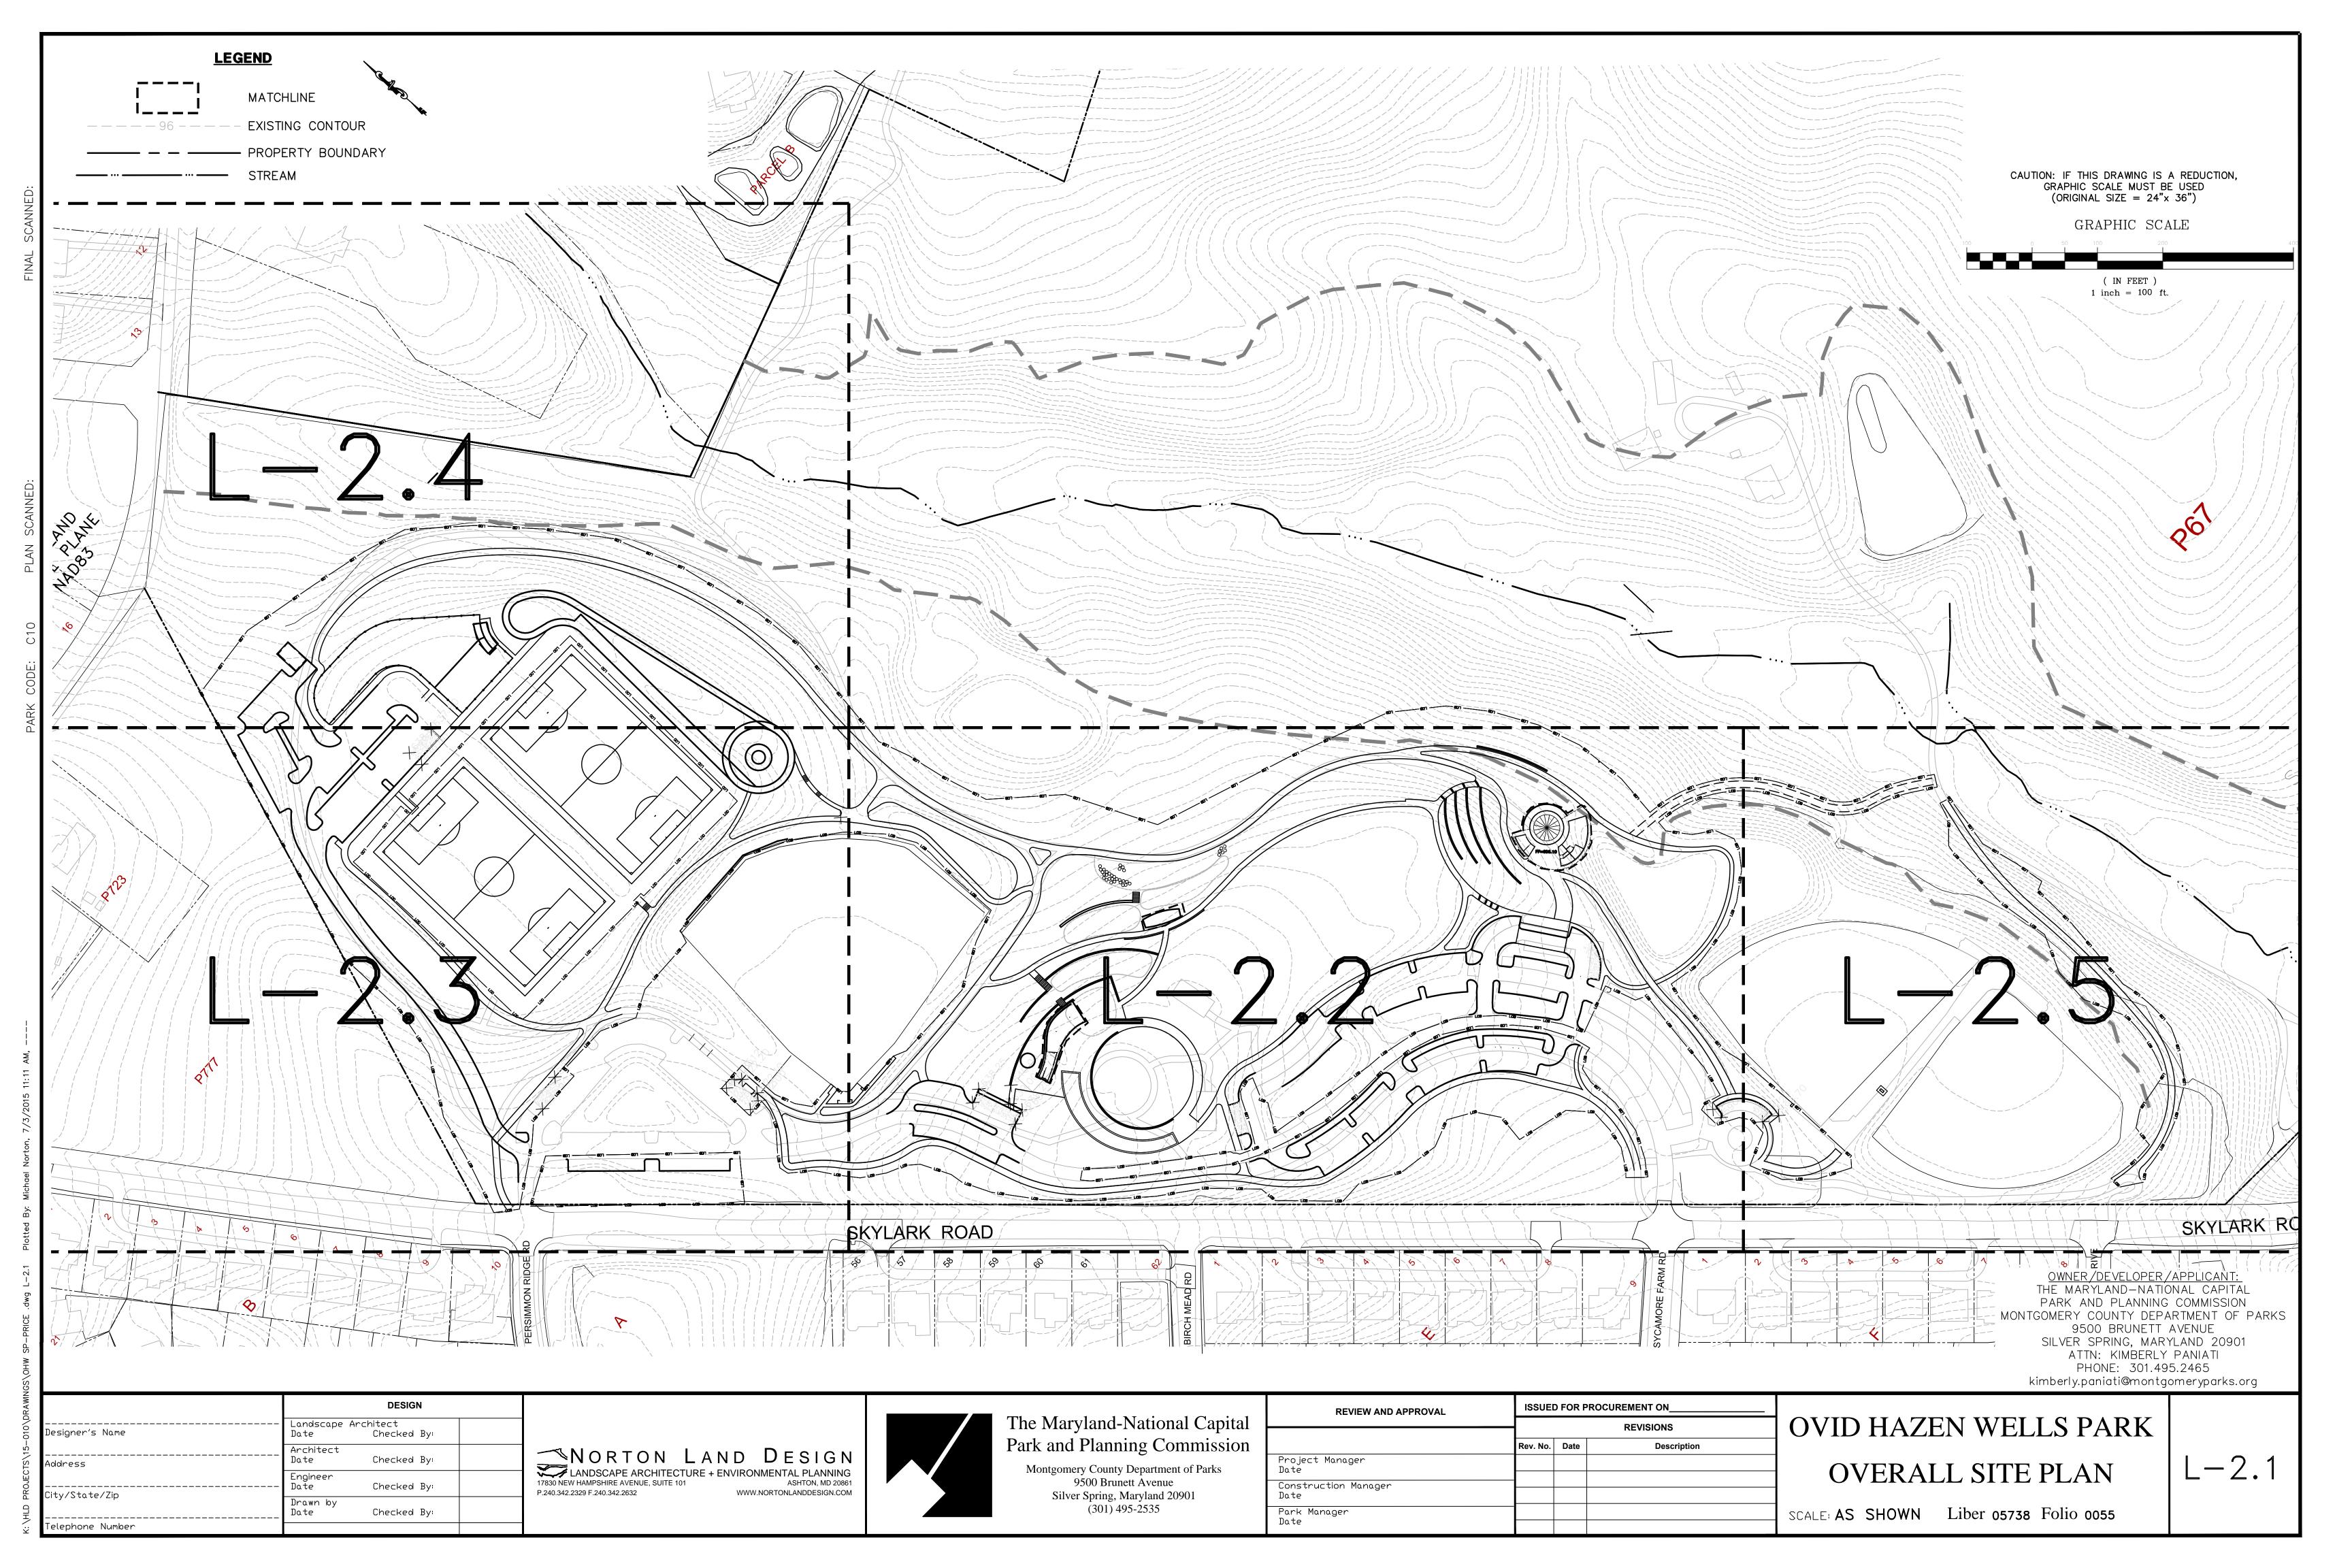
OVID HAZEN WELLS PARK TITLE SHEET


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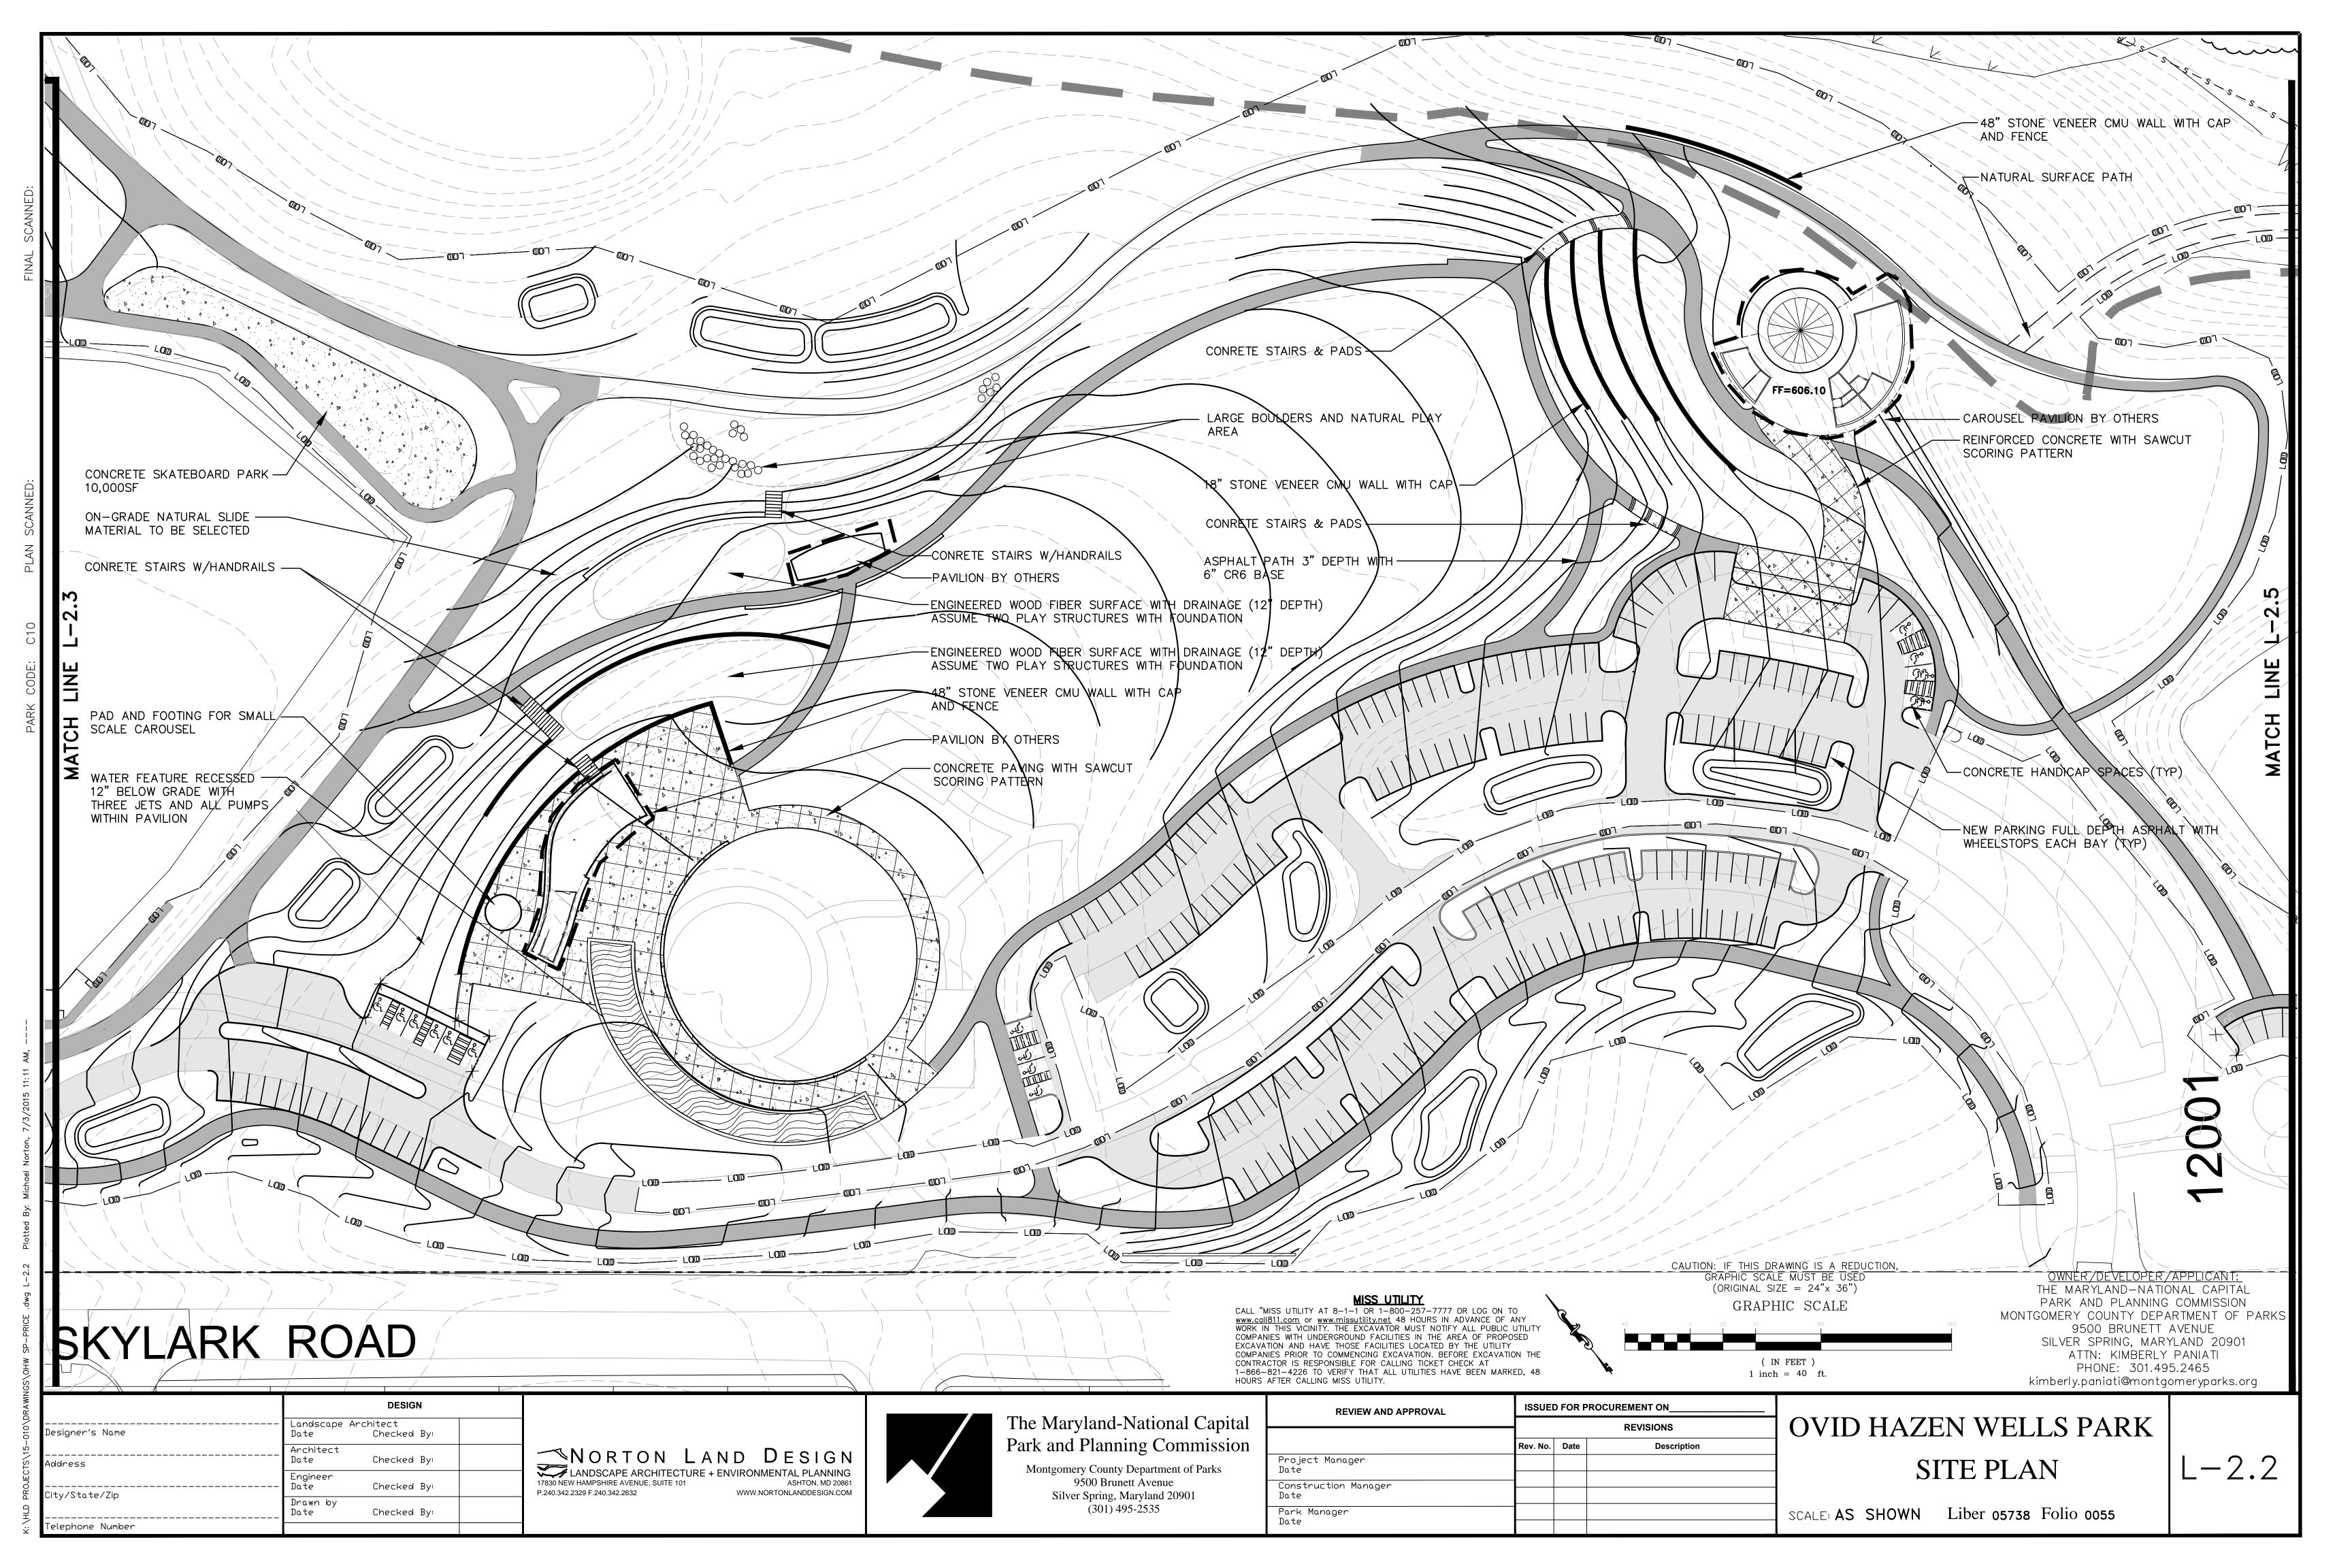
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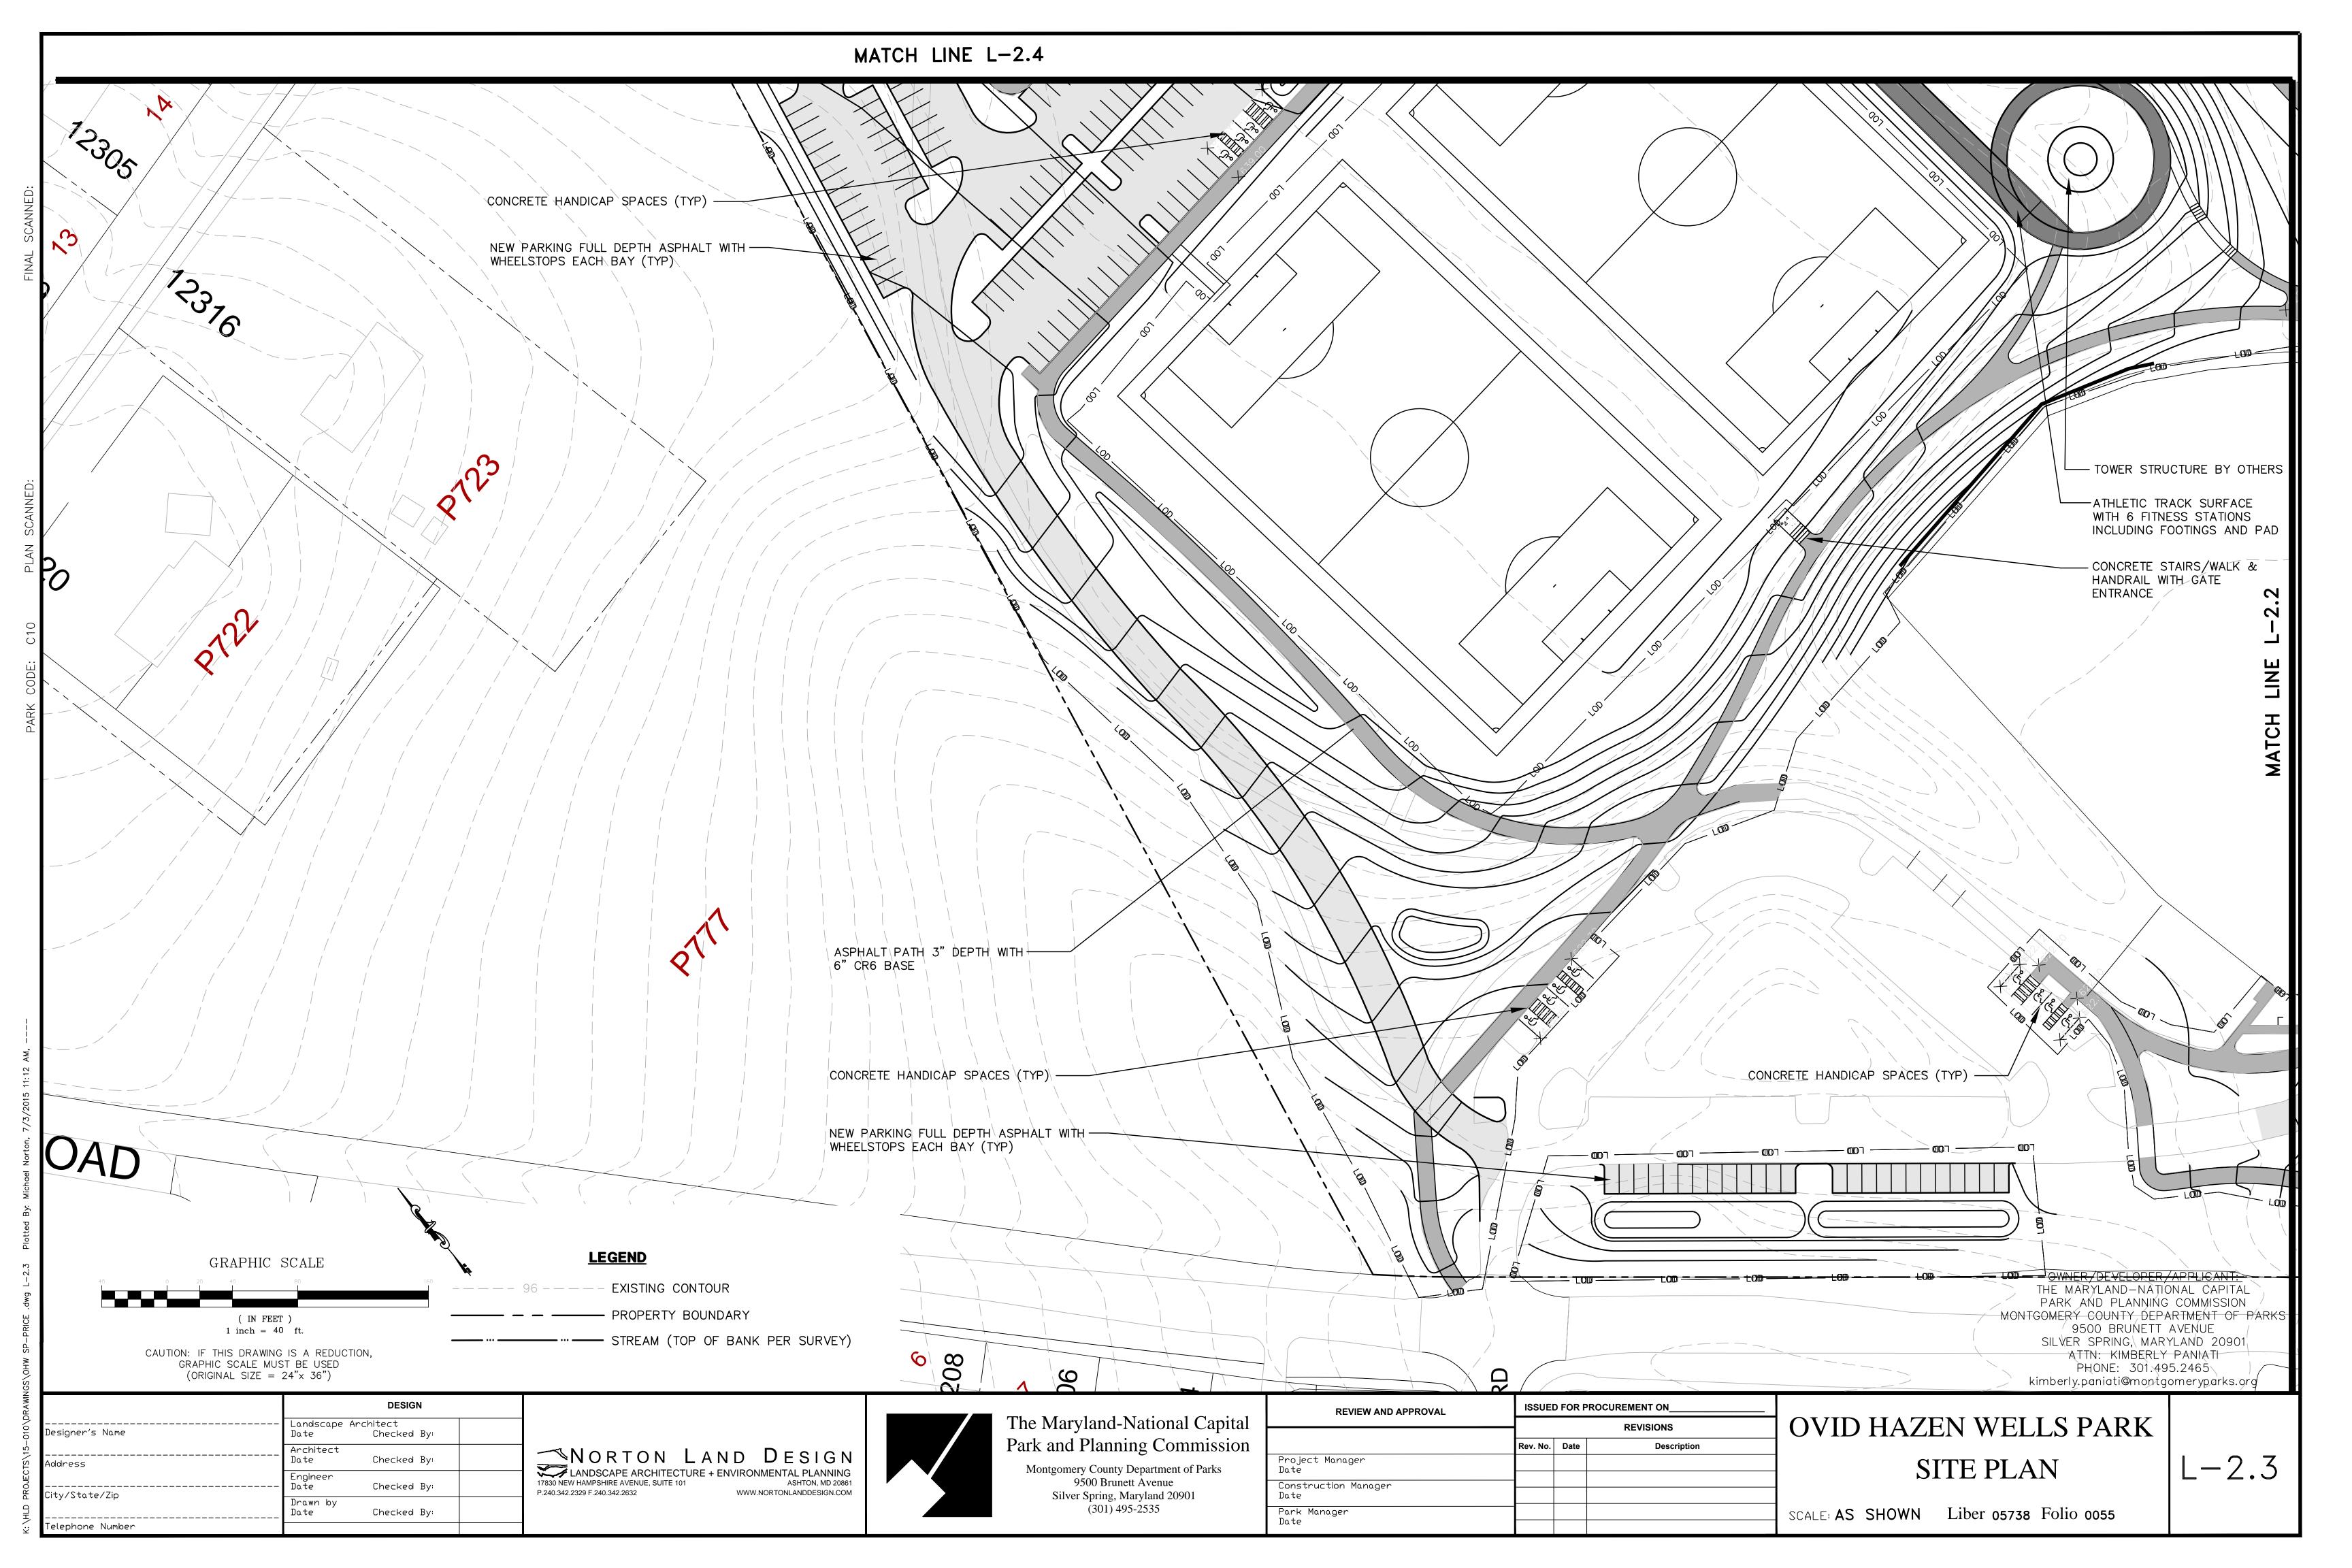








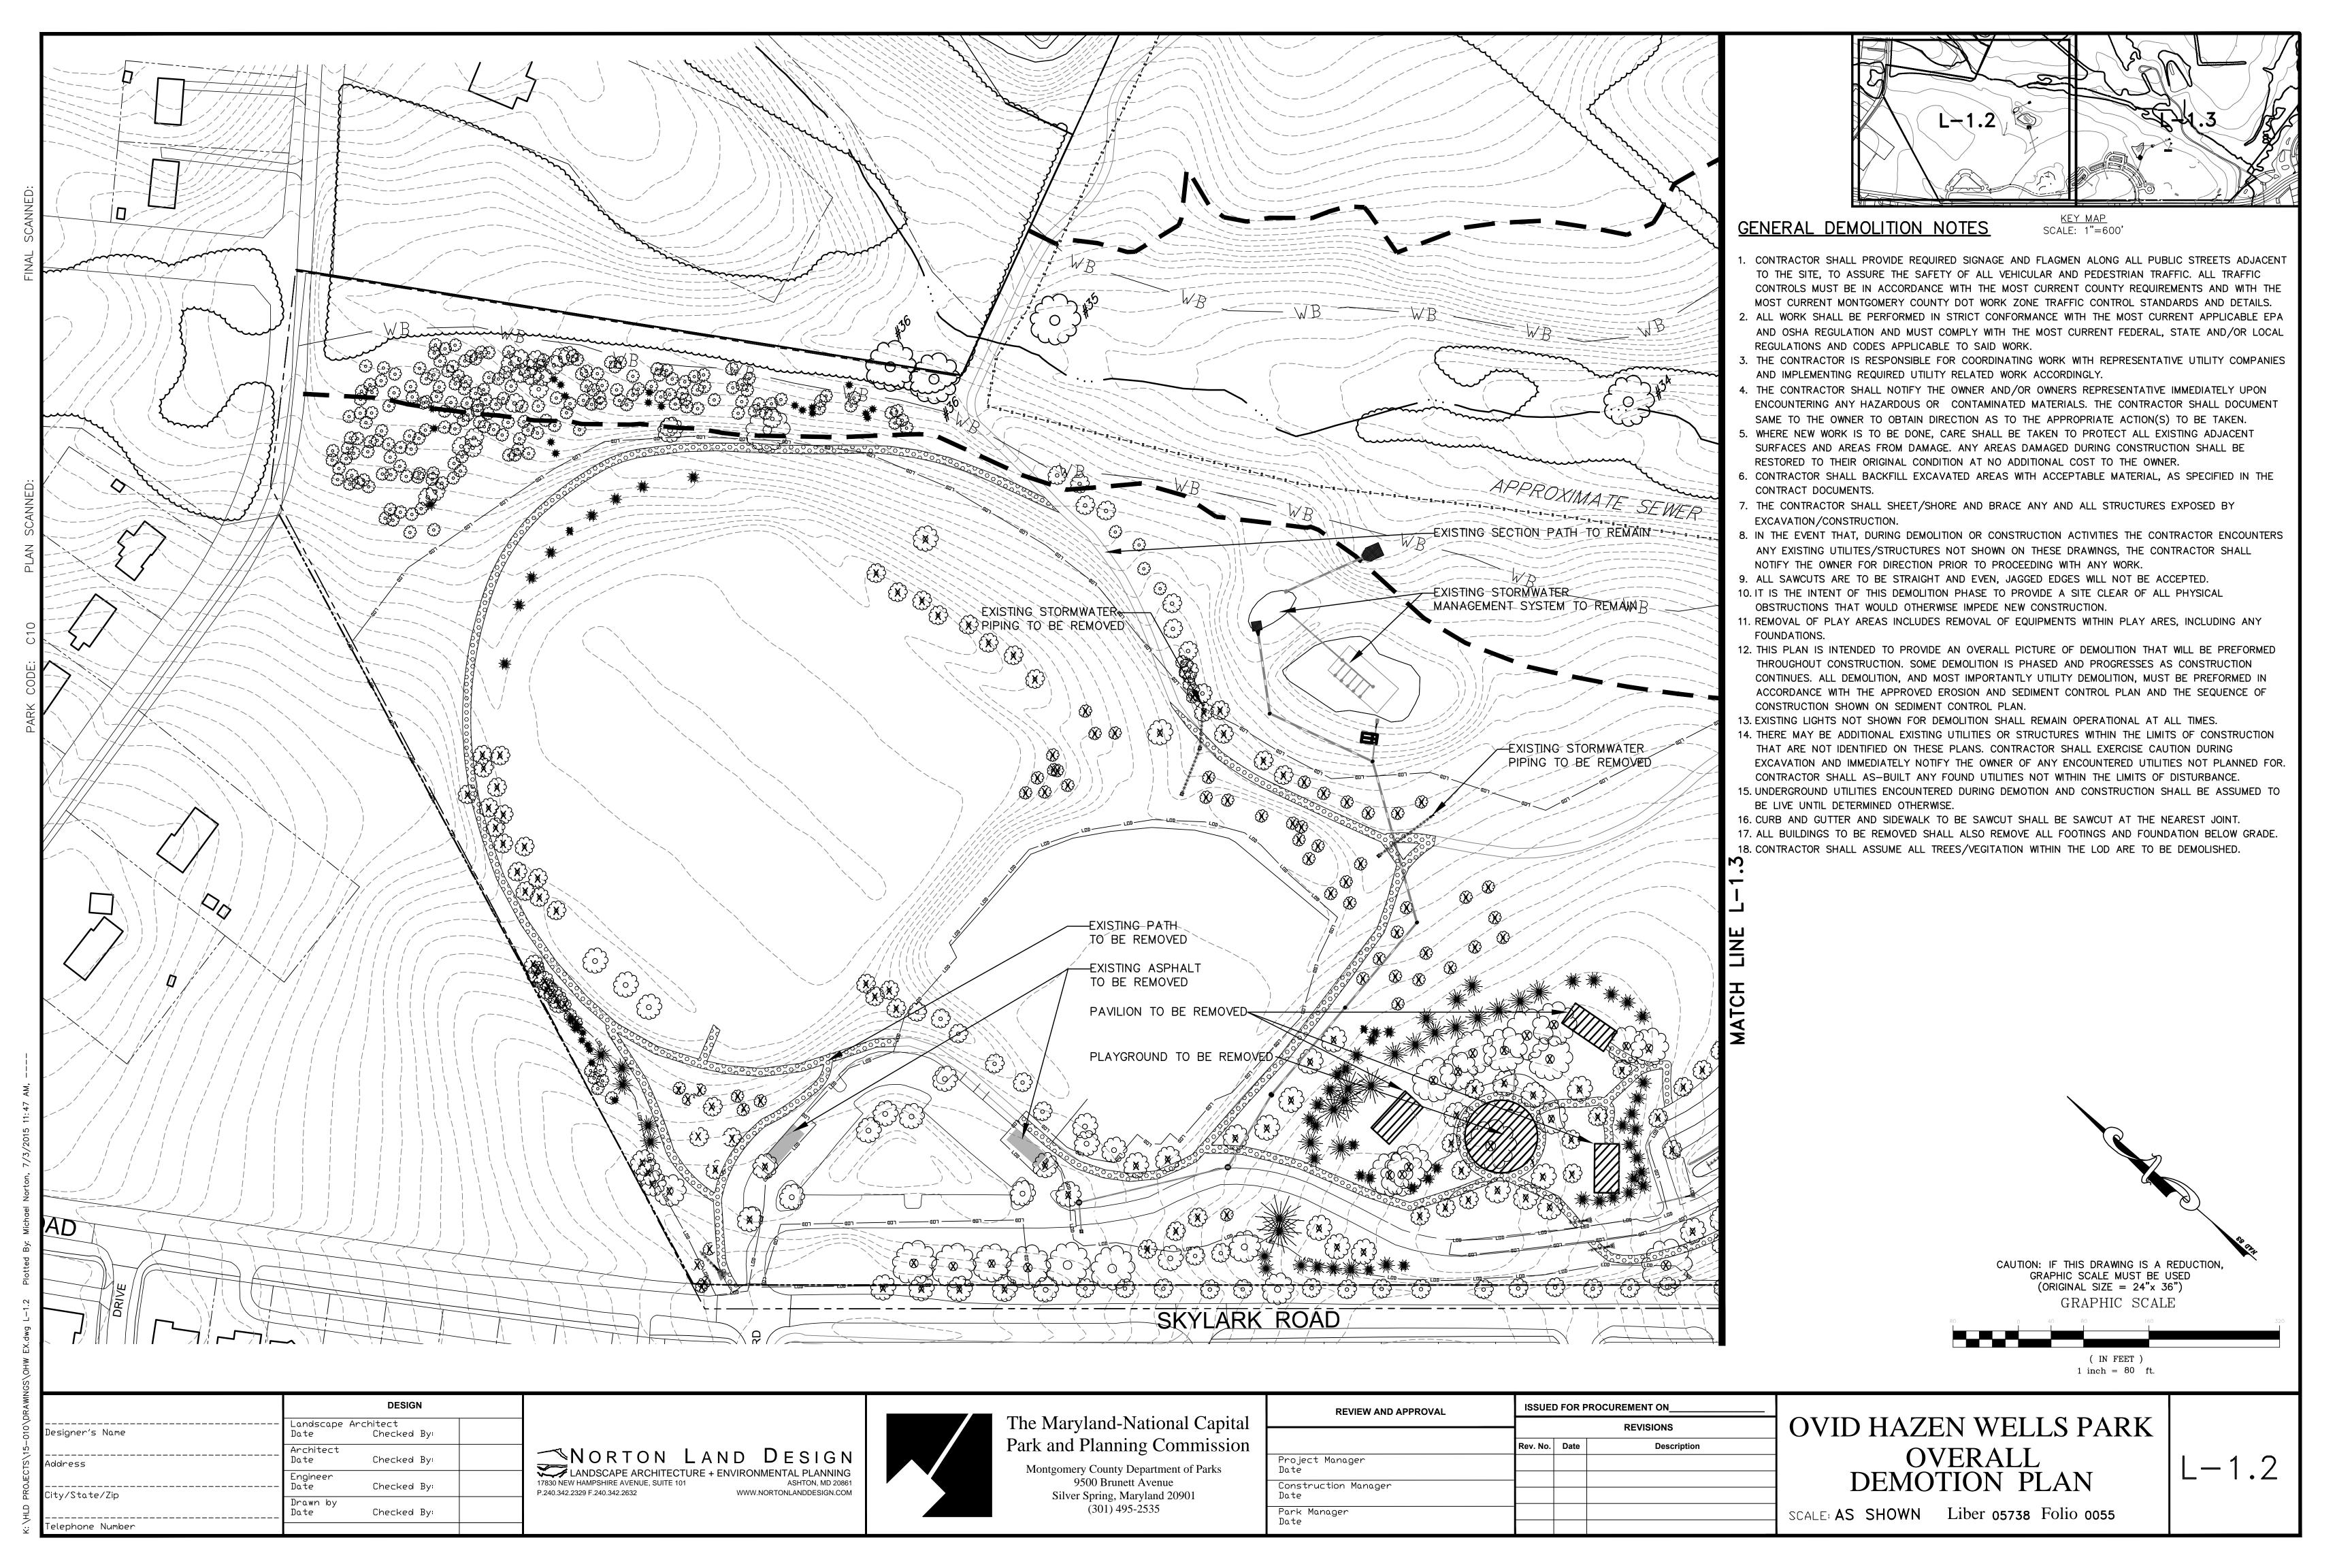


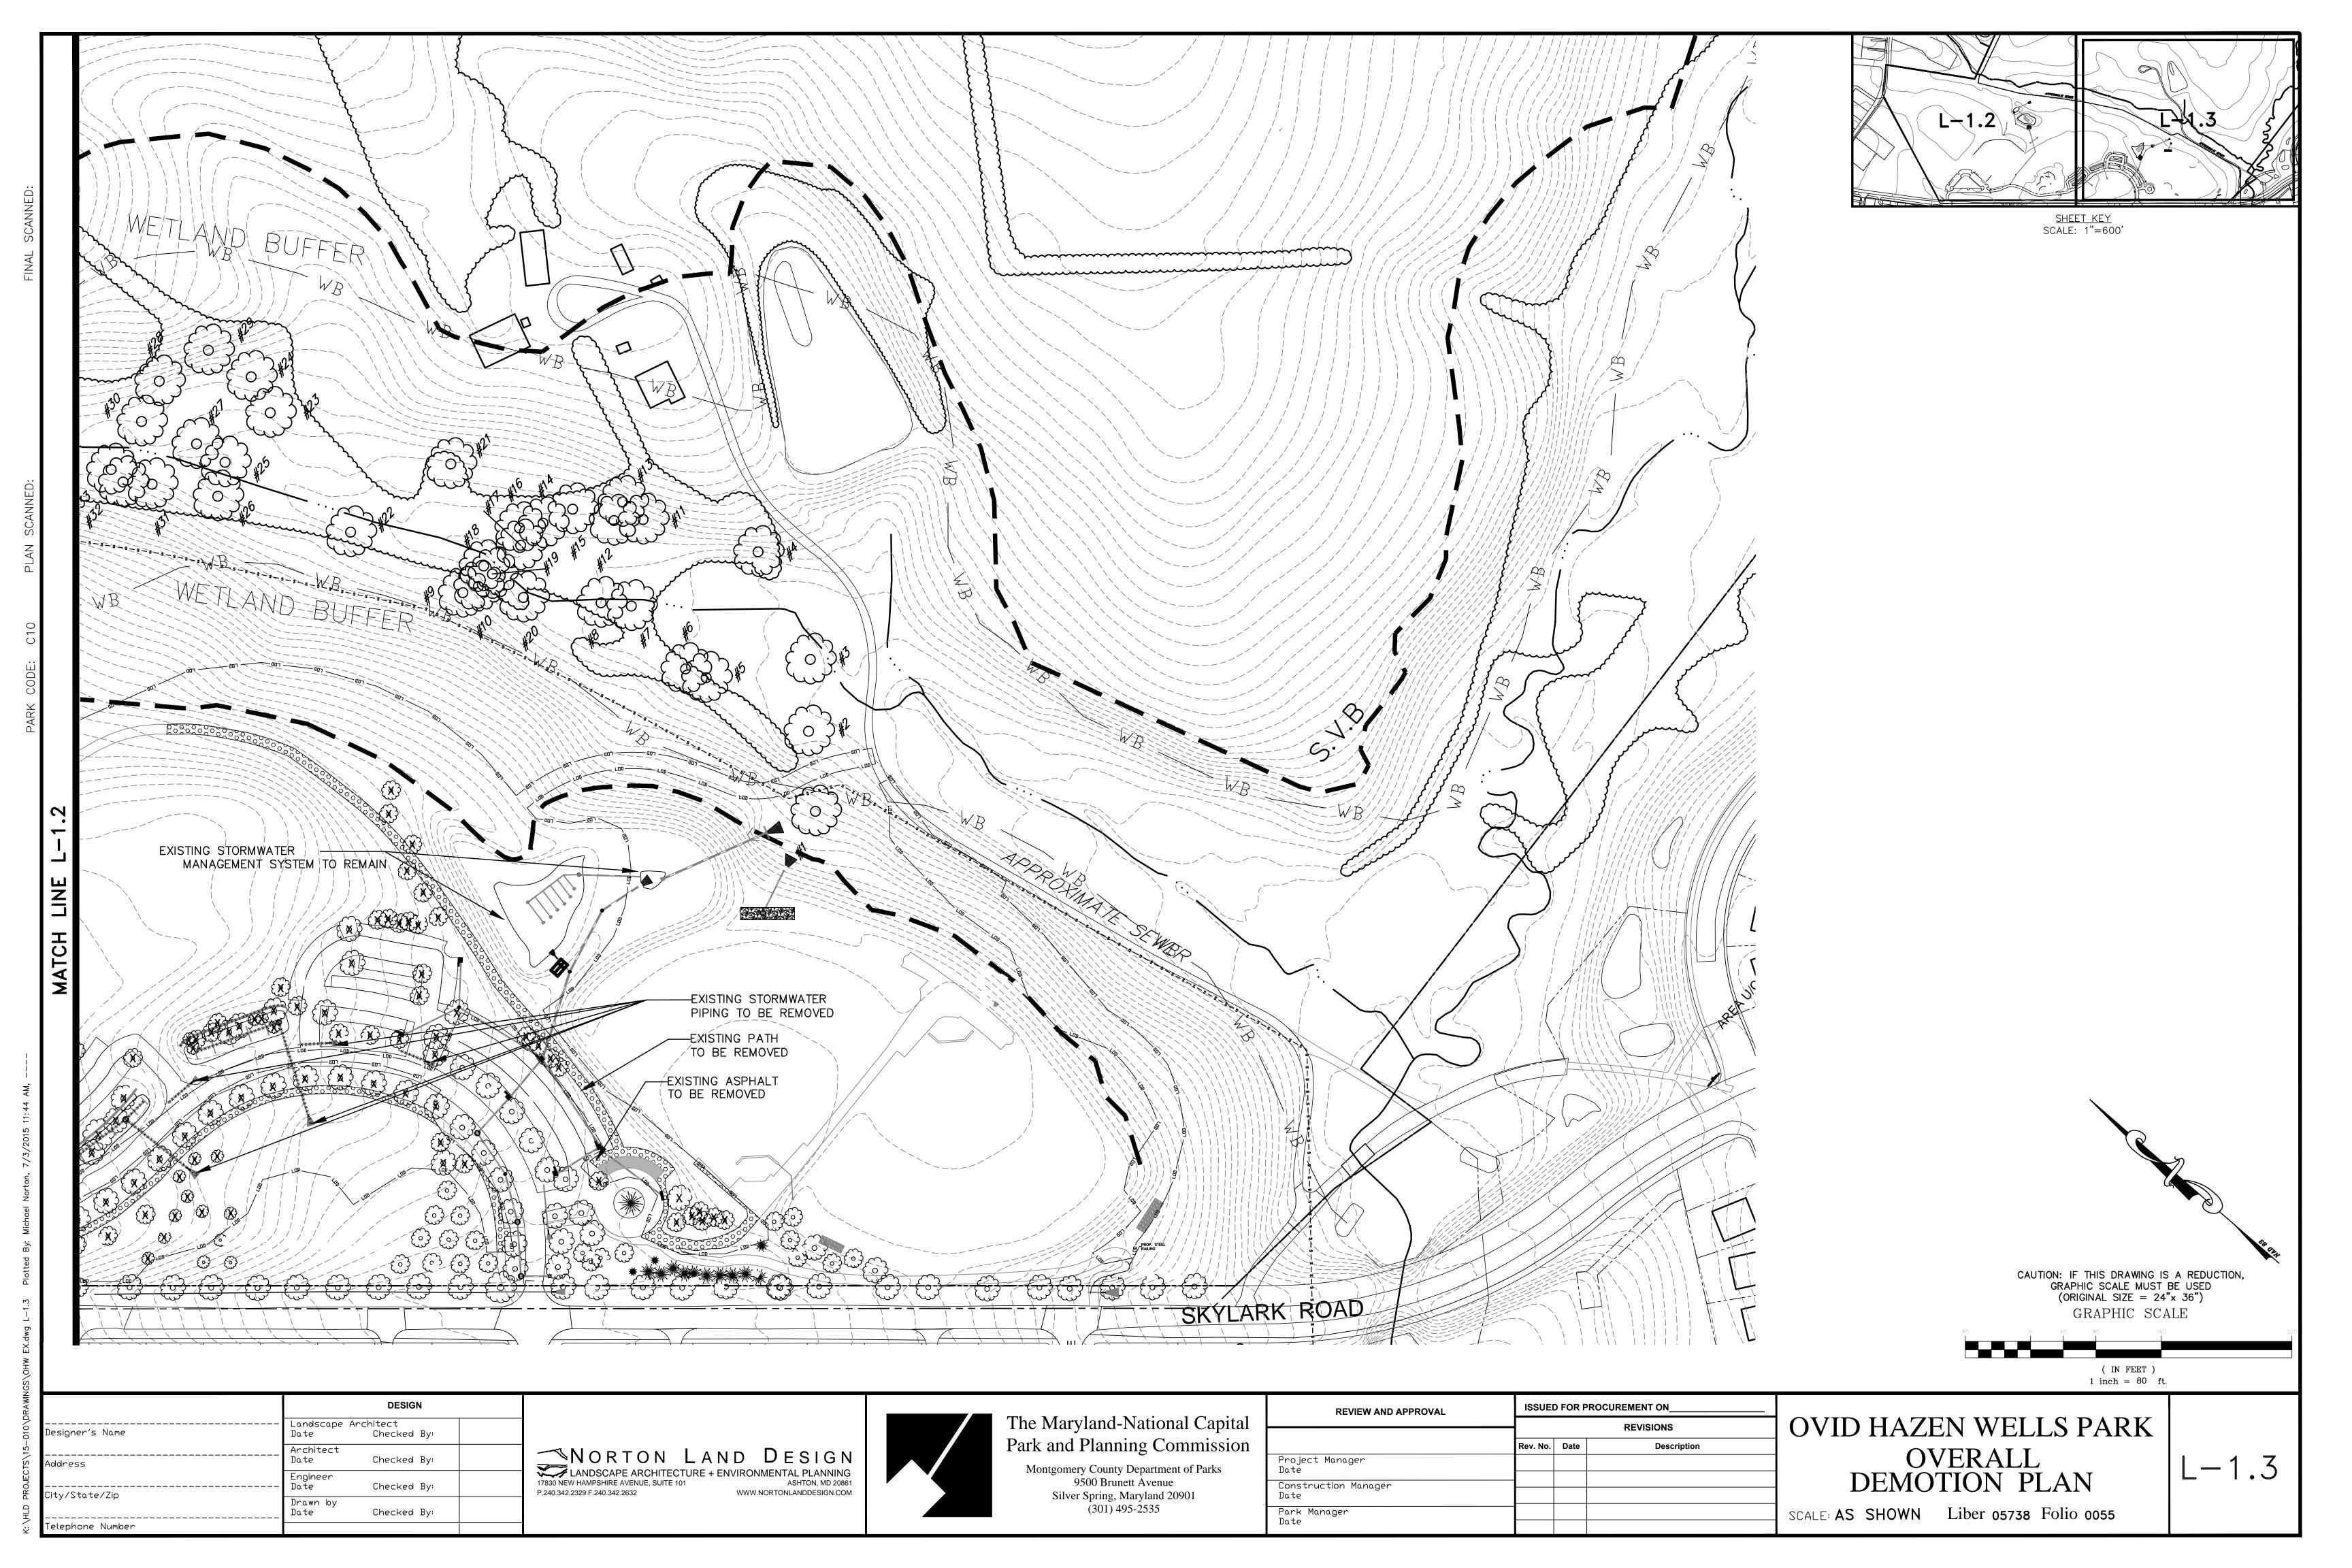


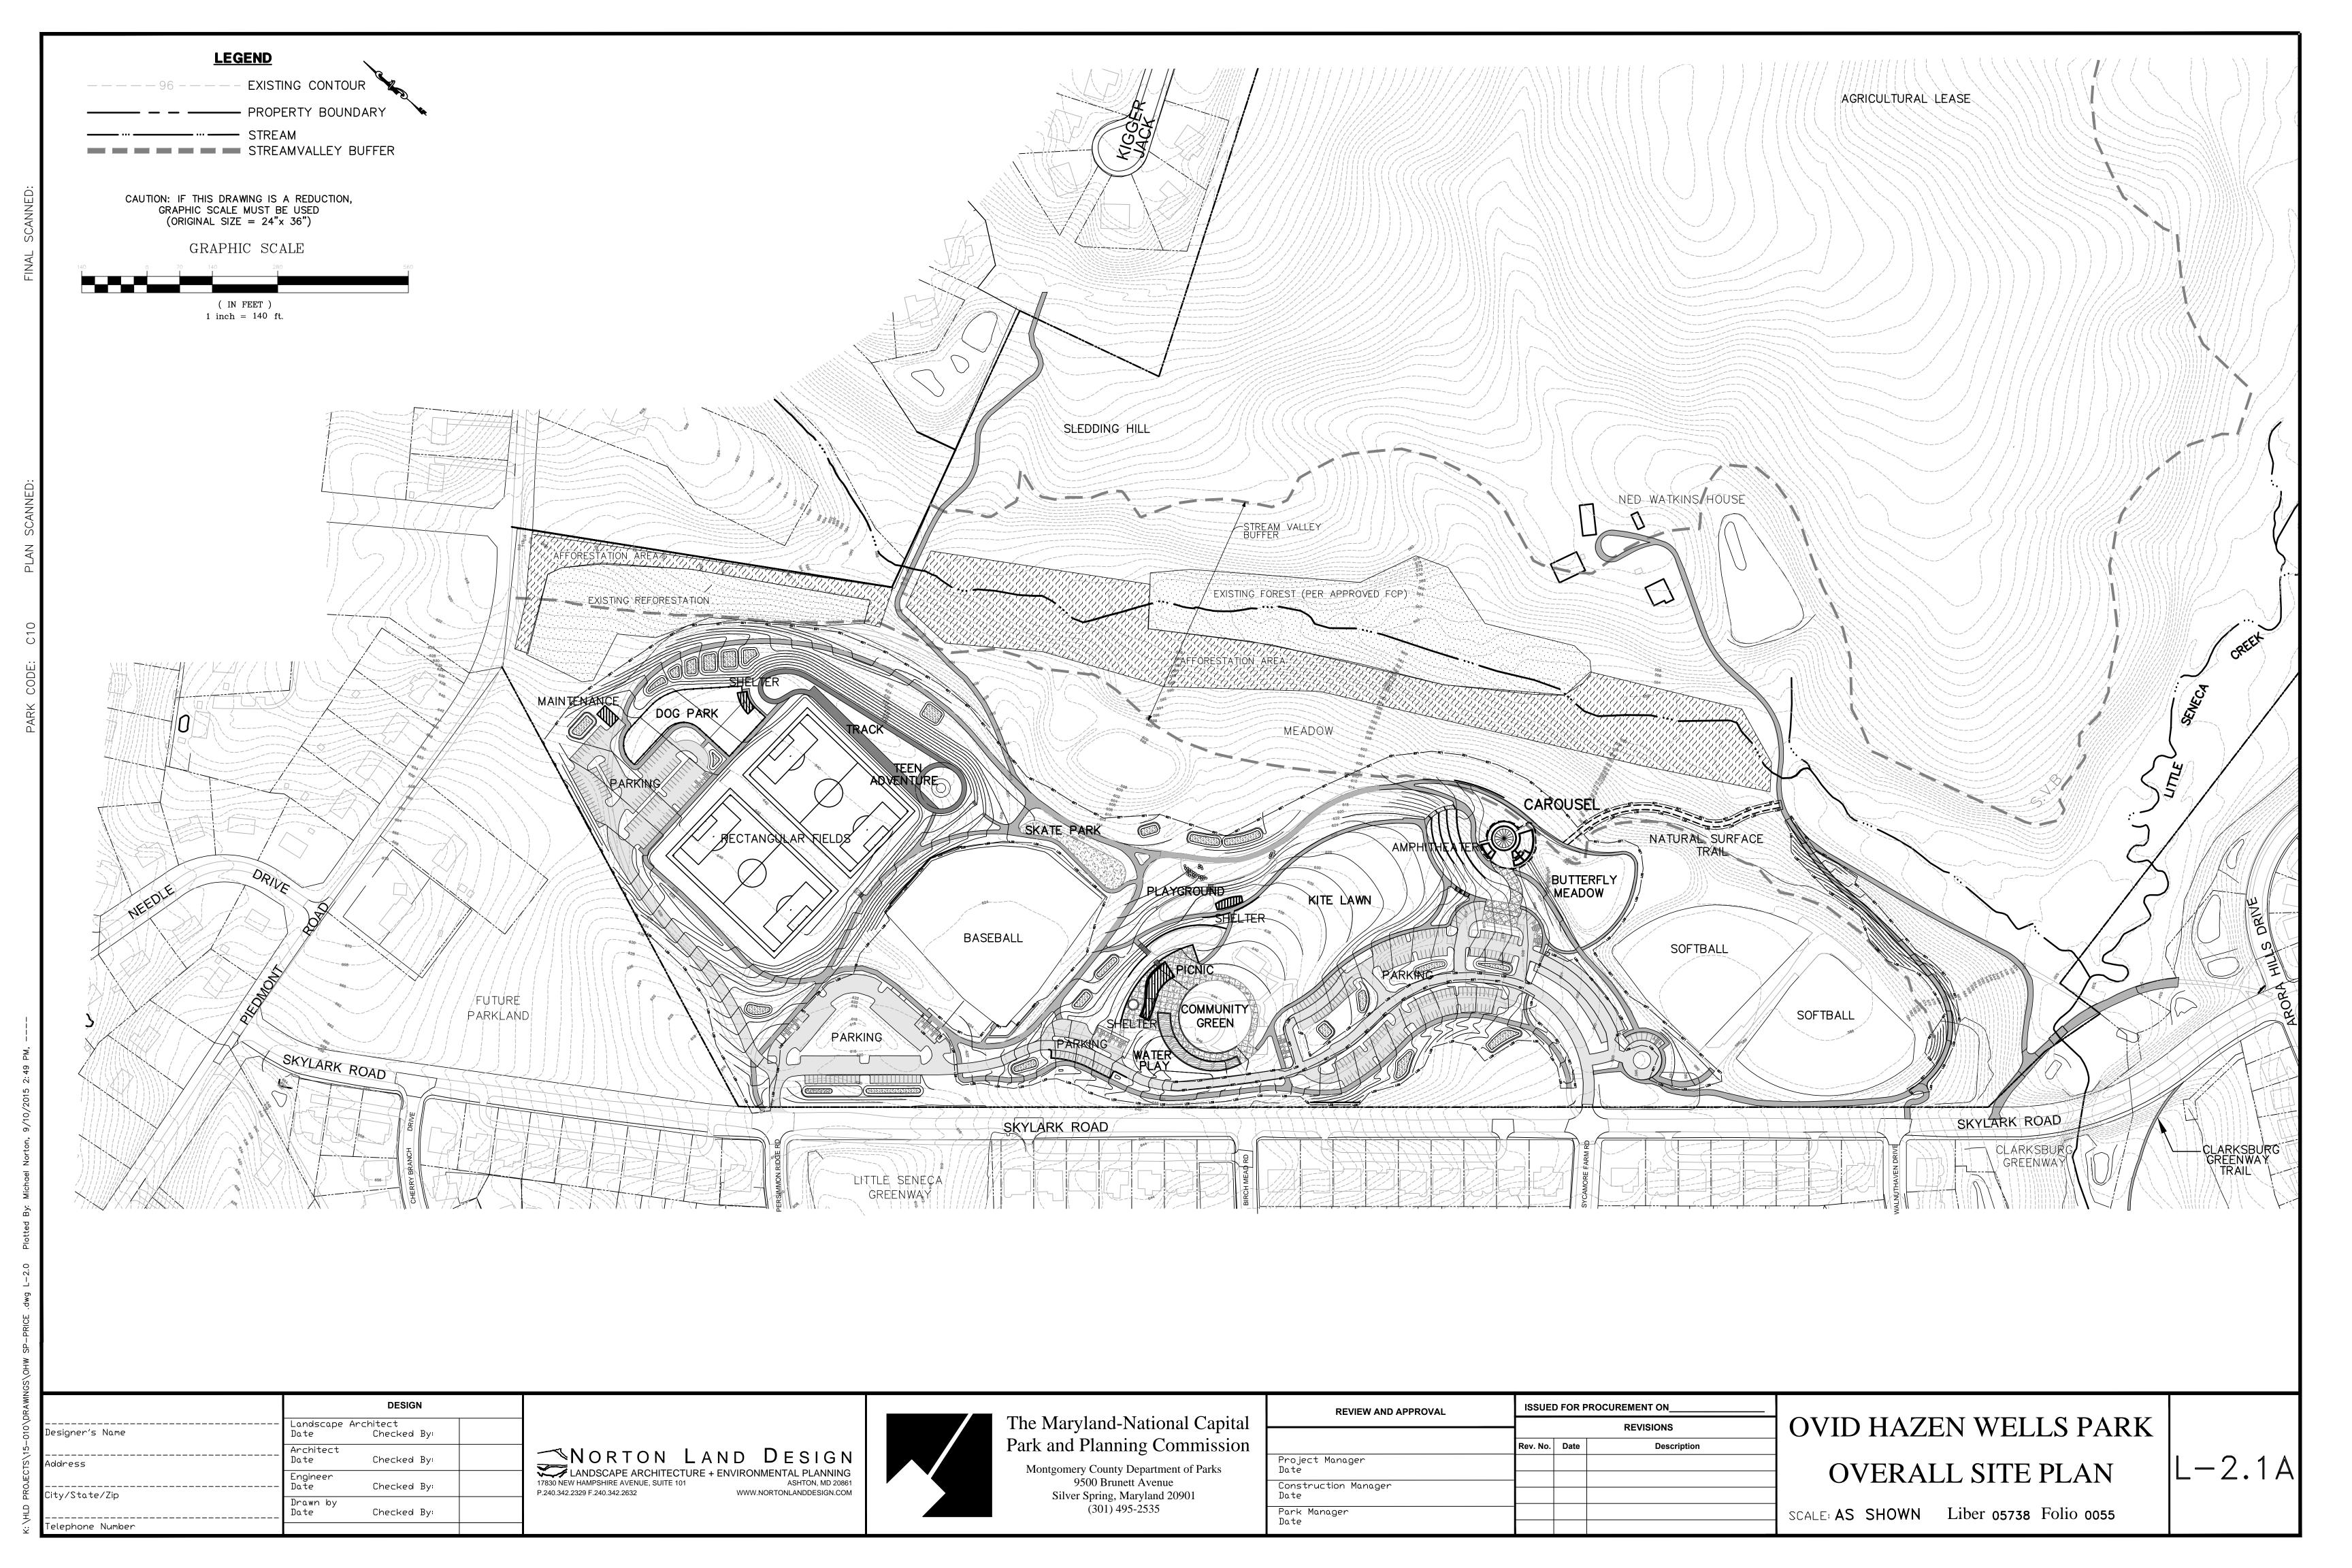


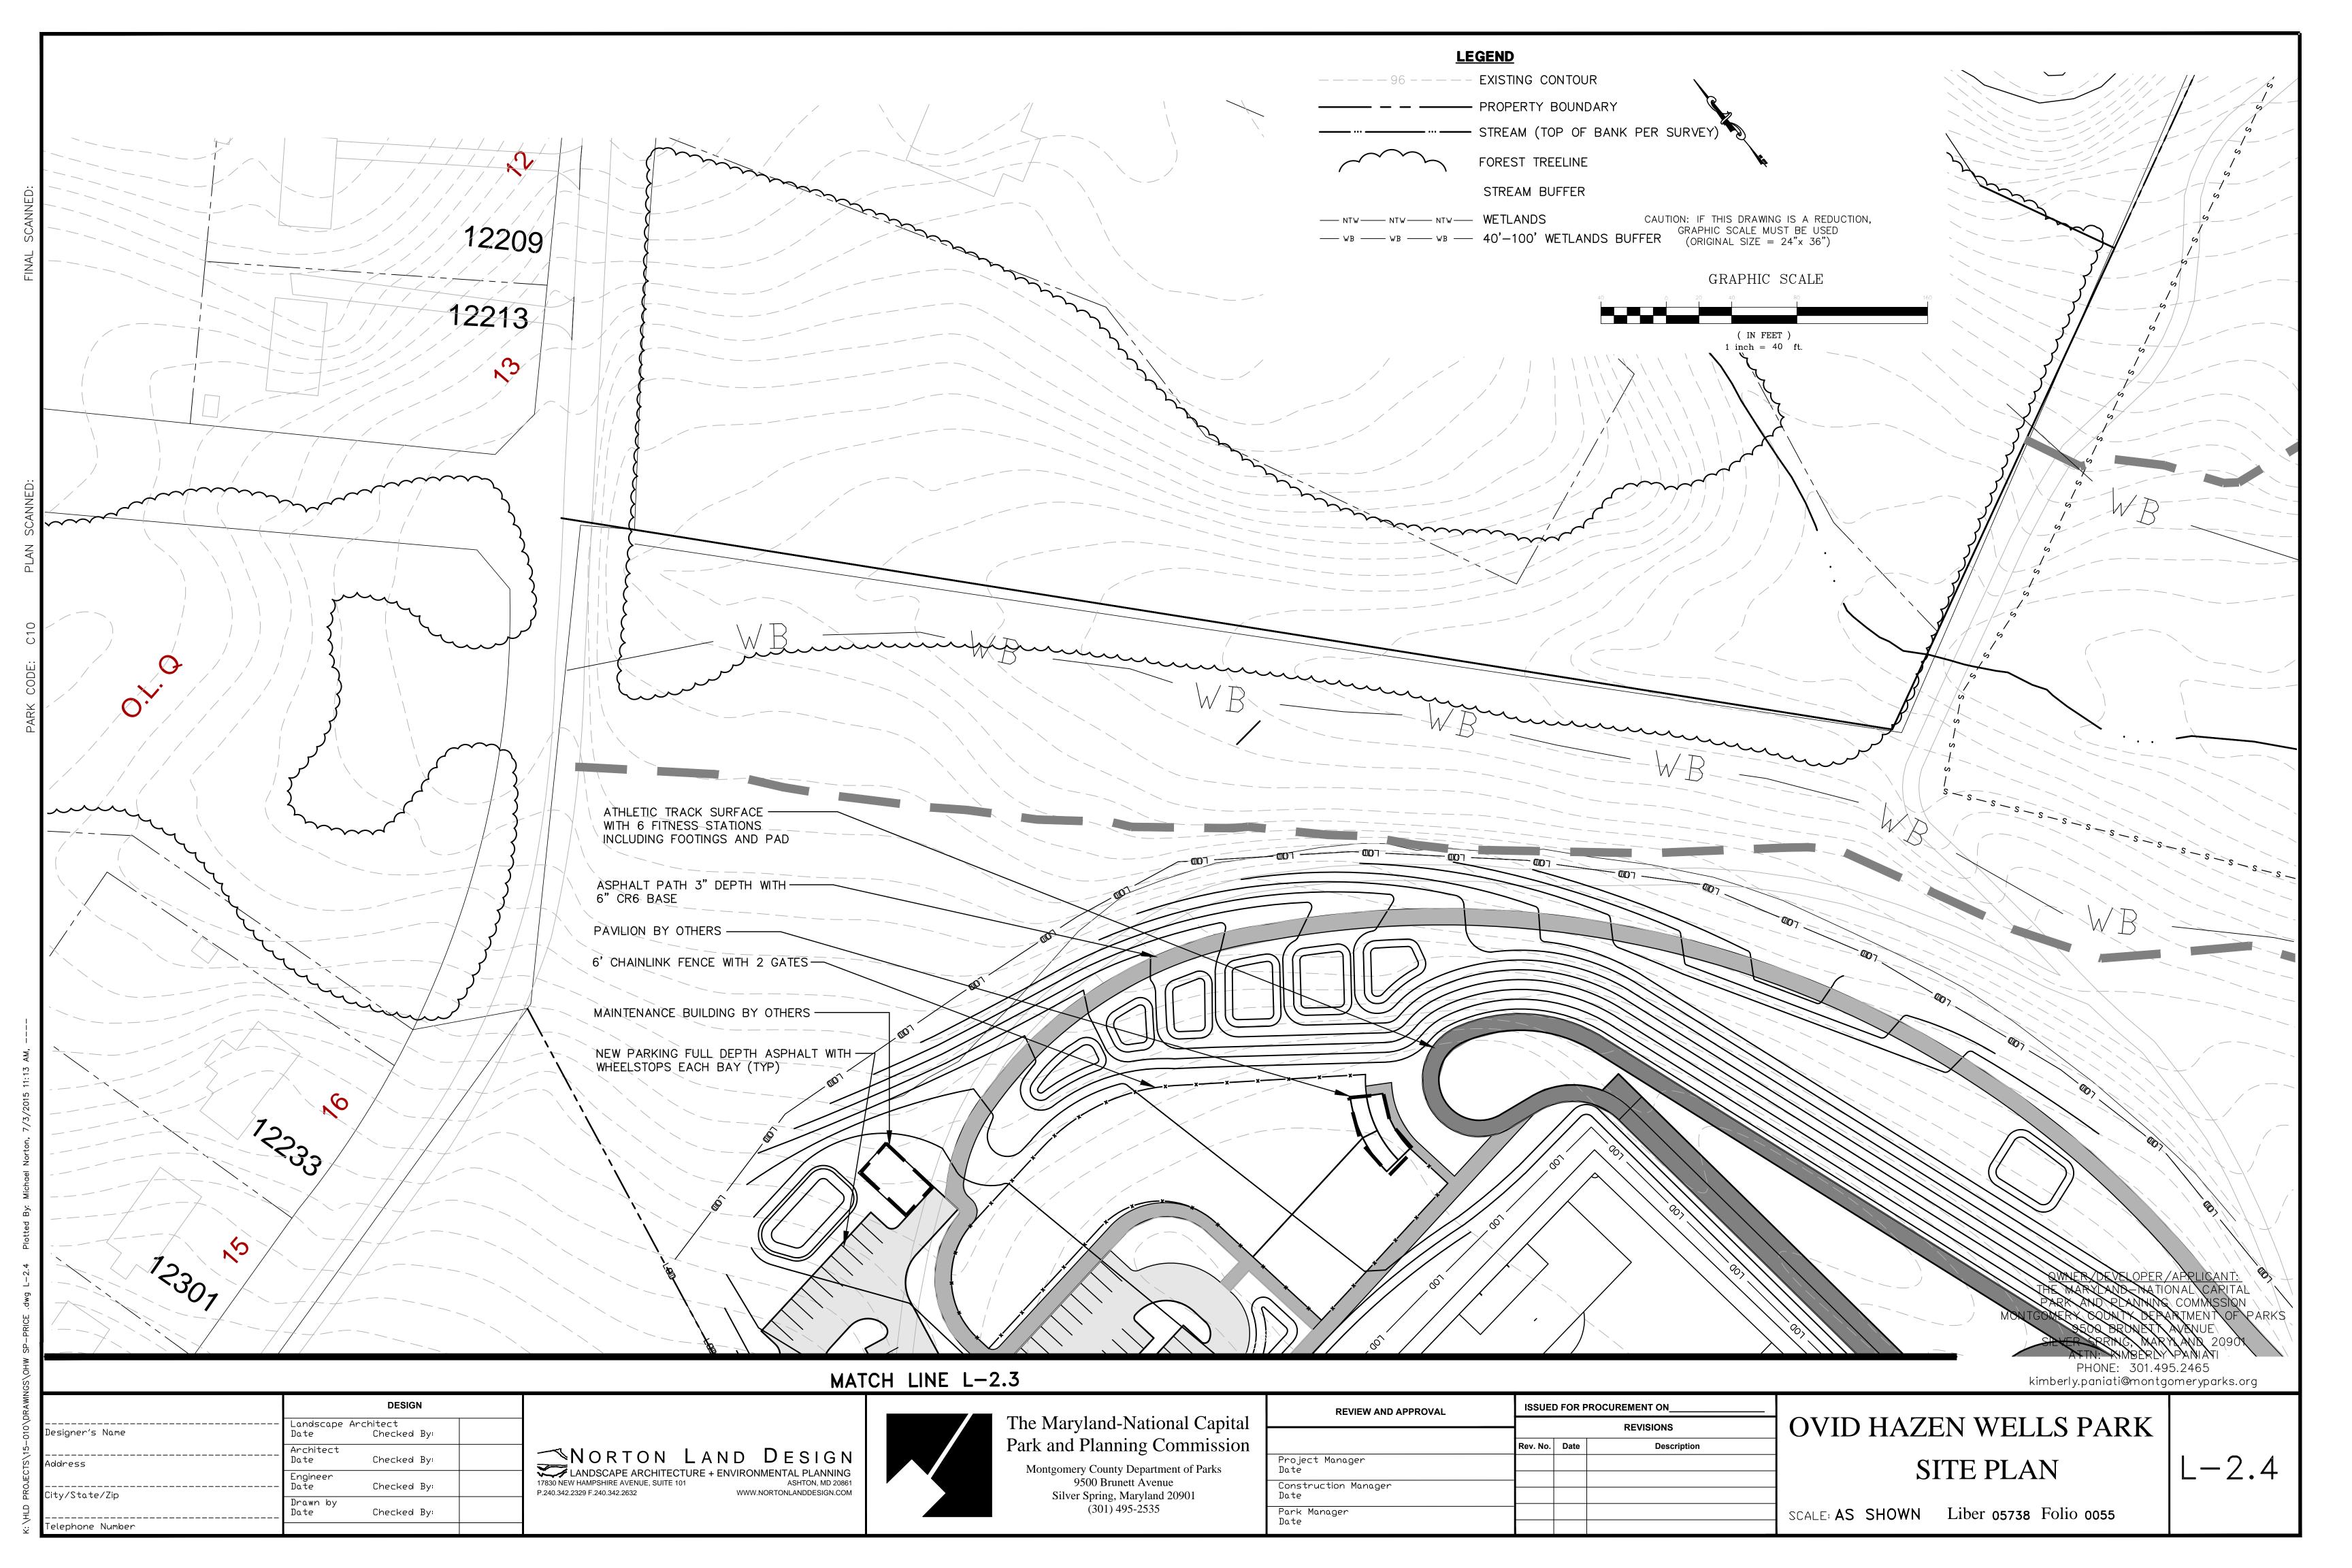


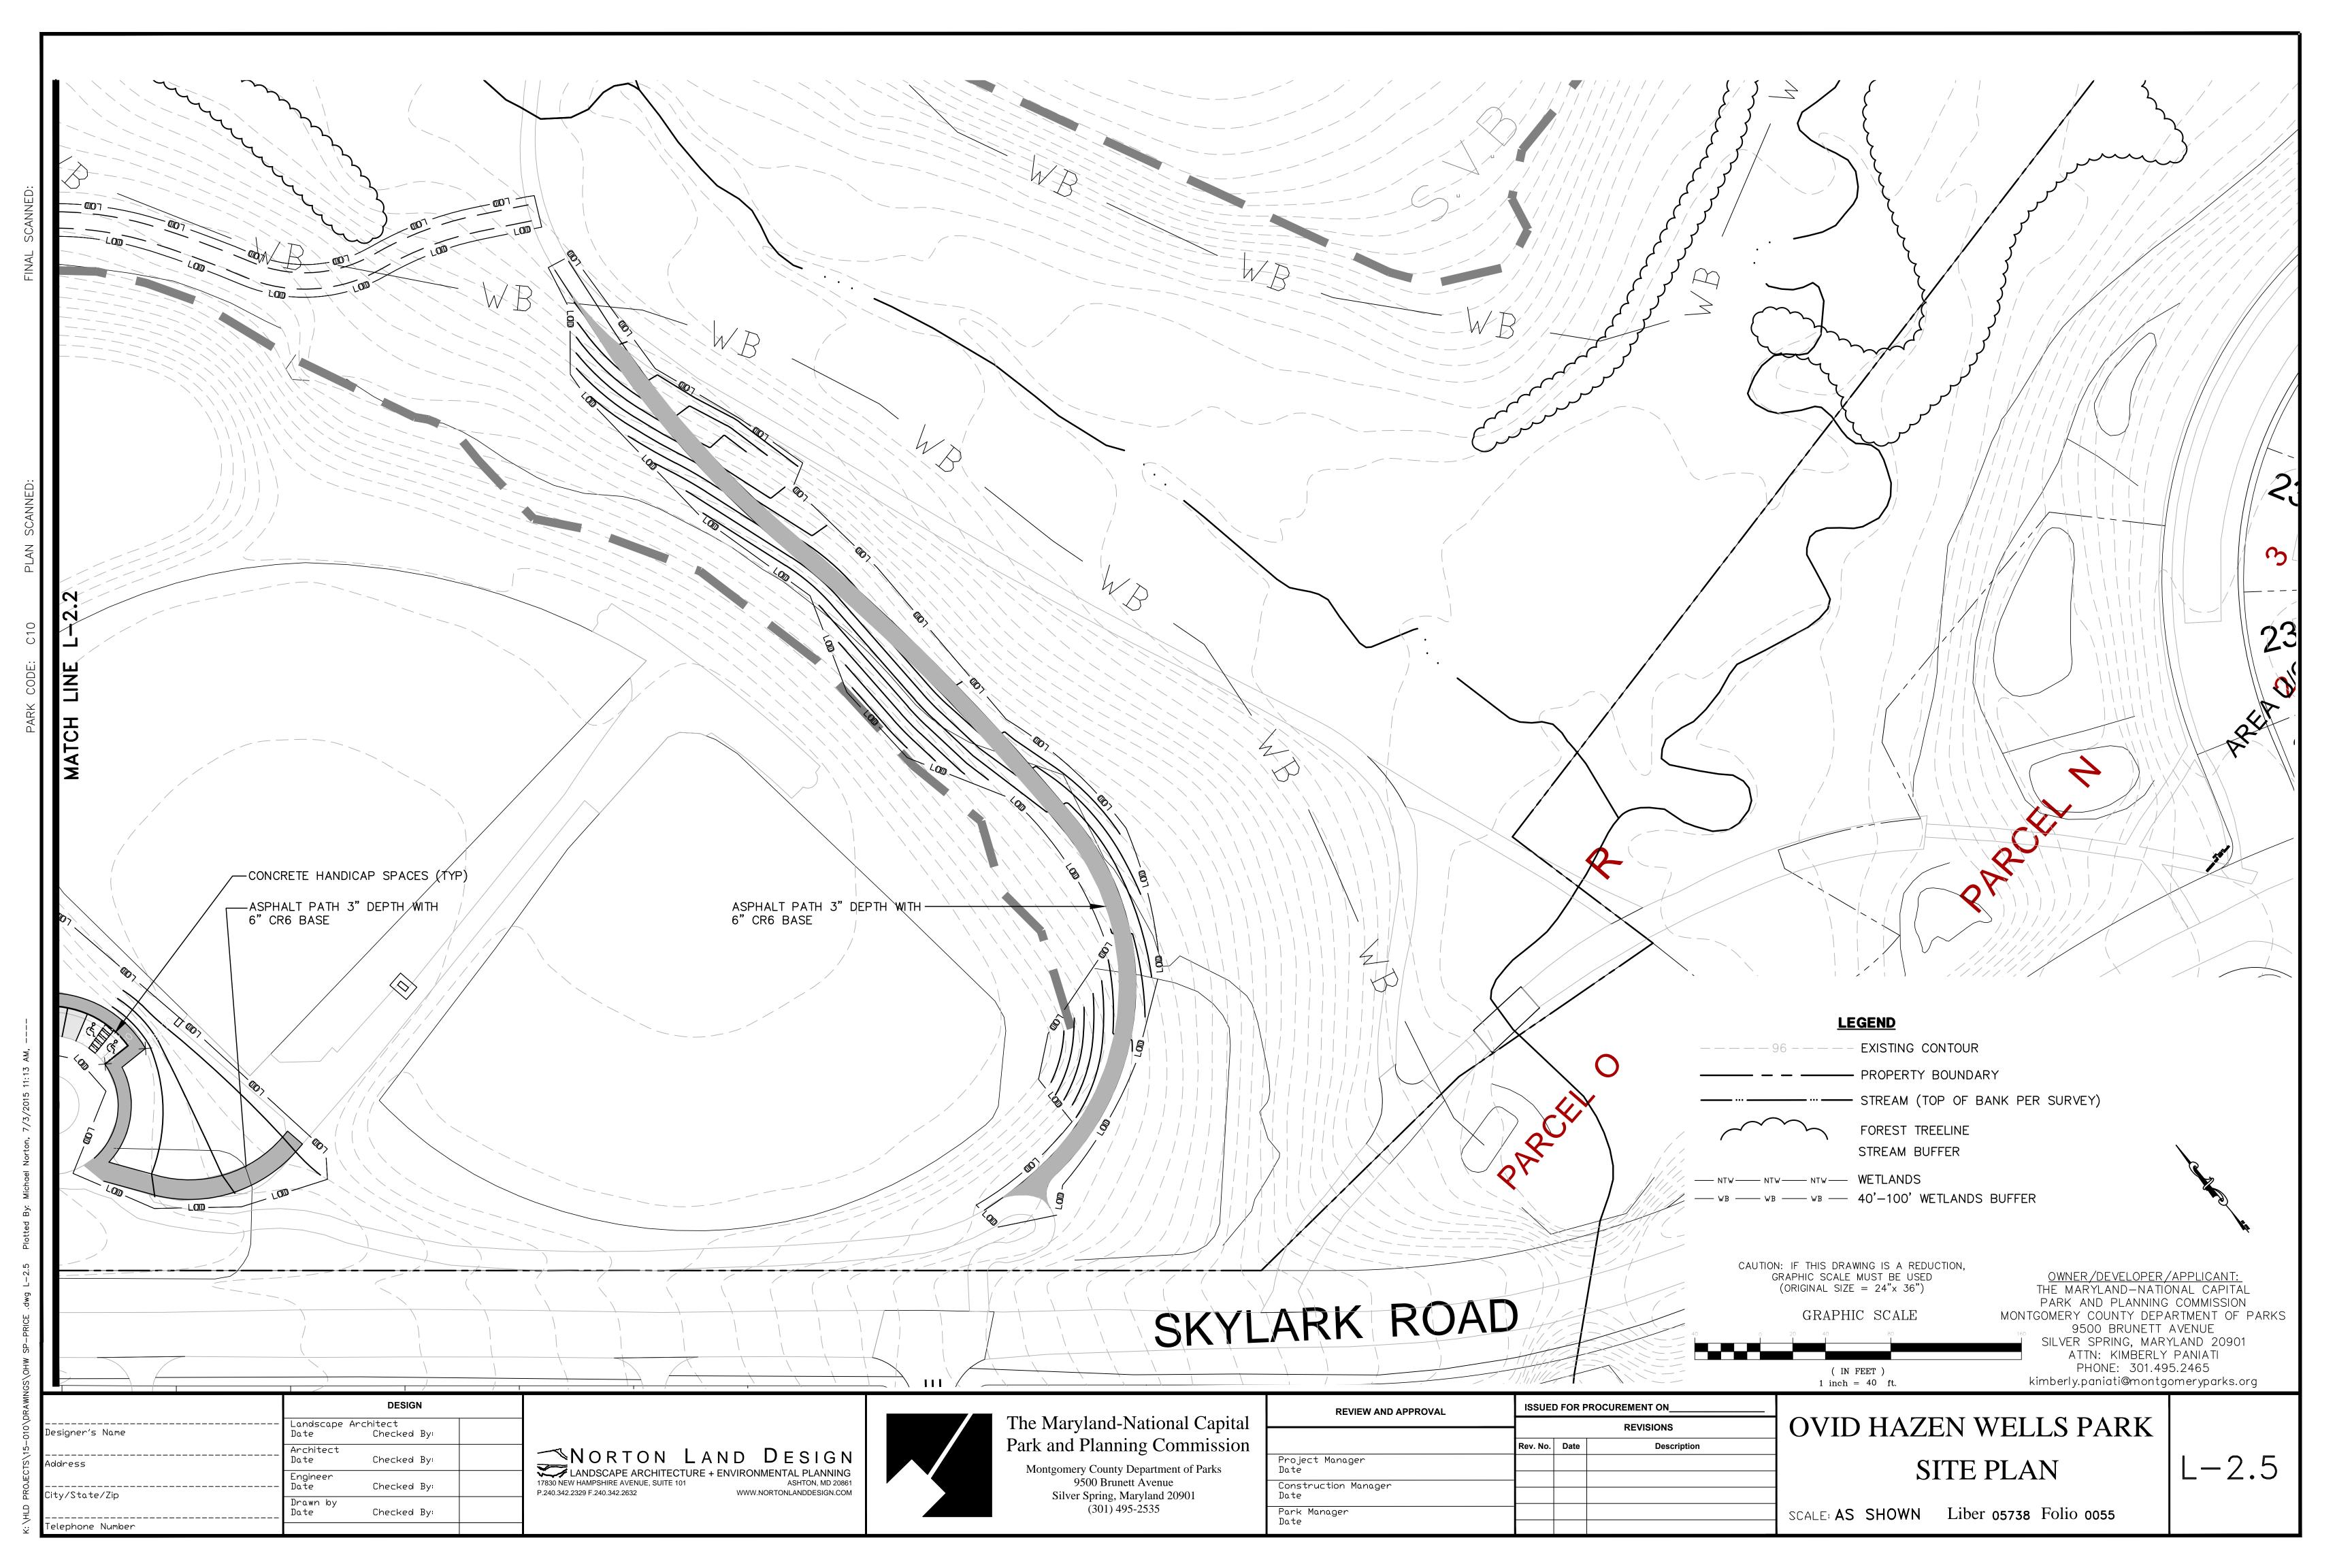


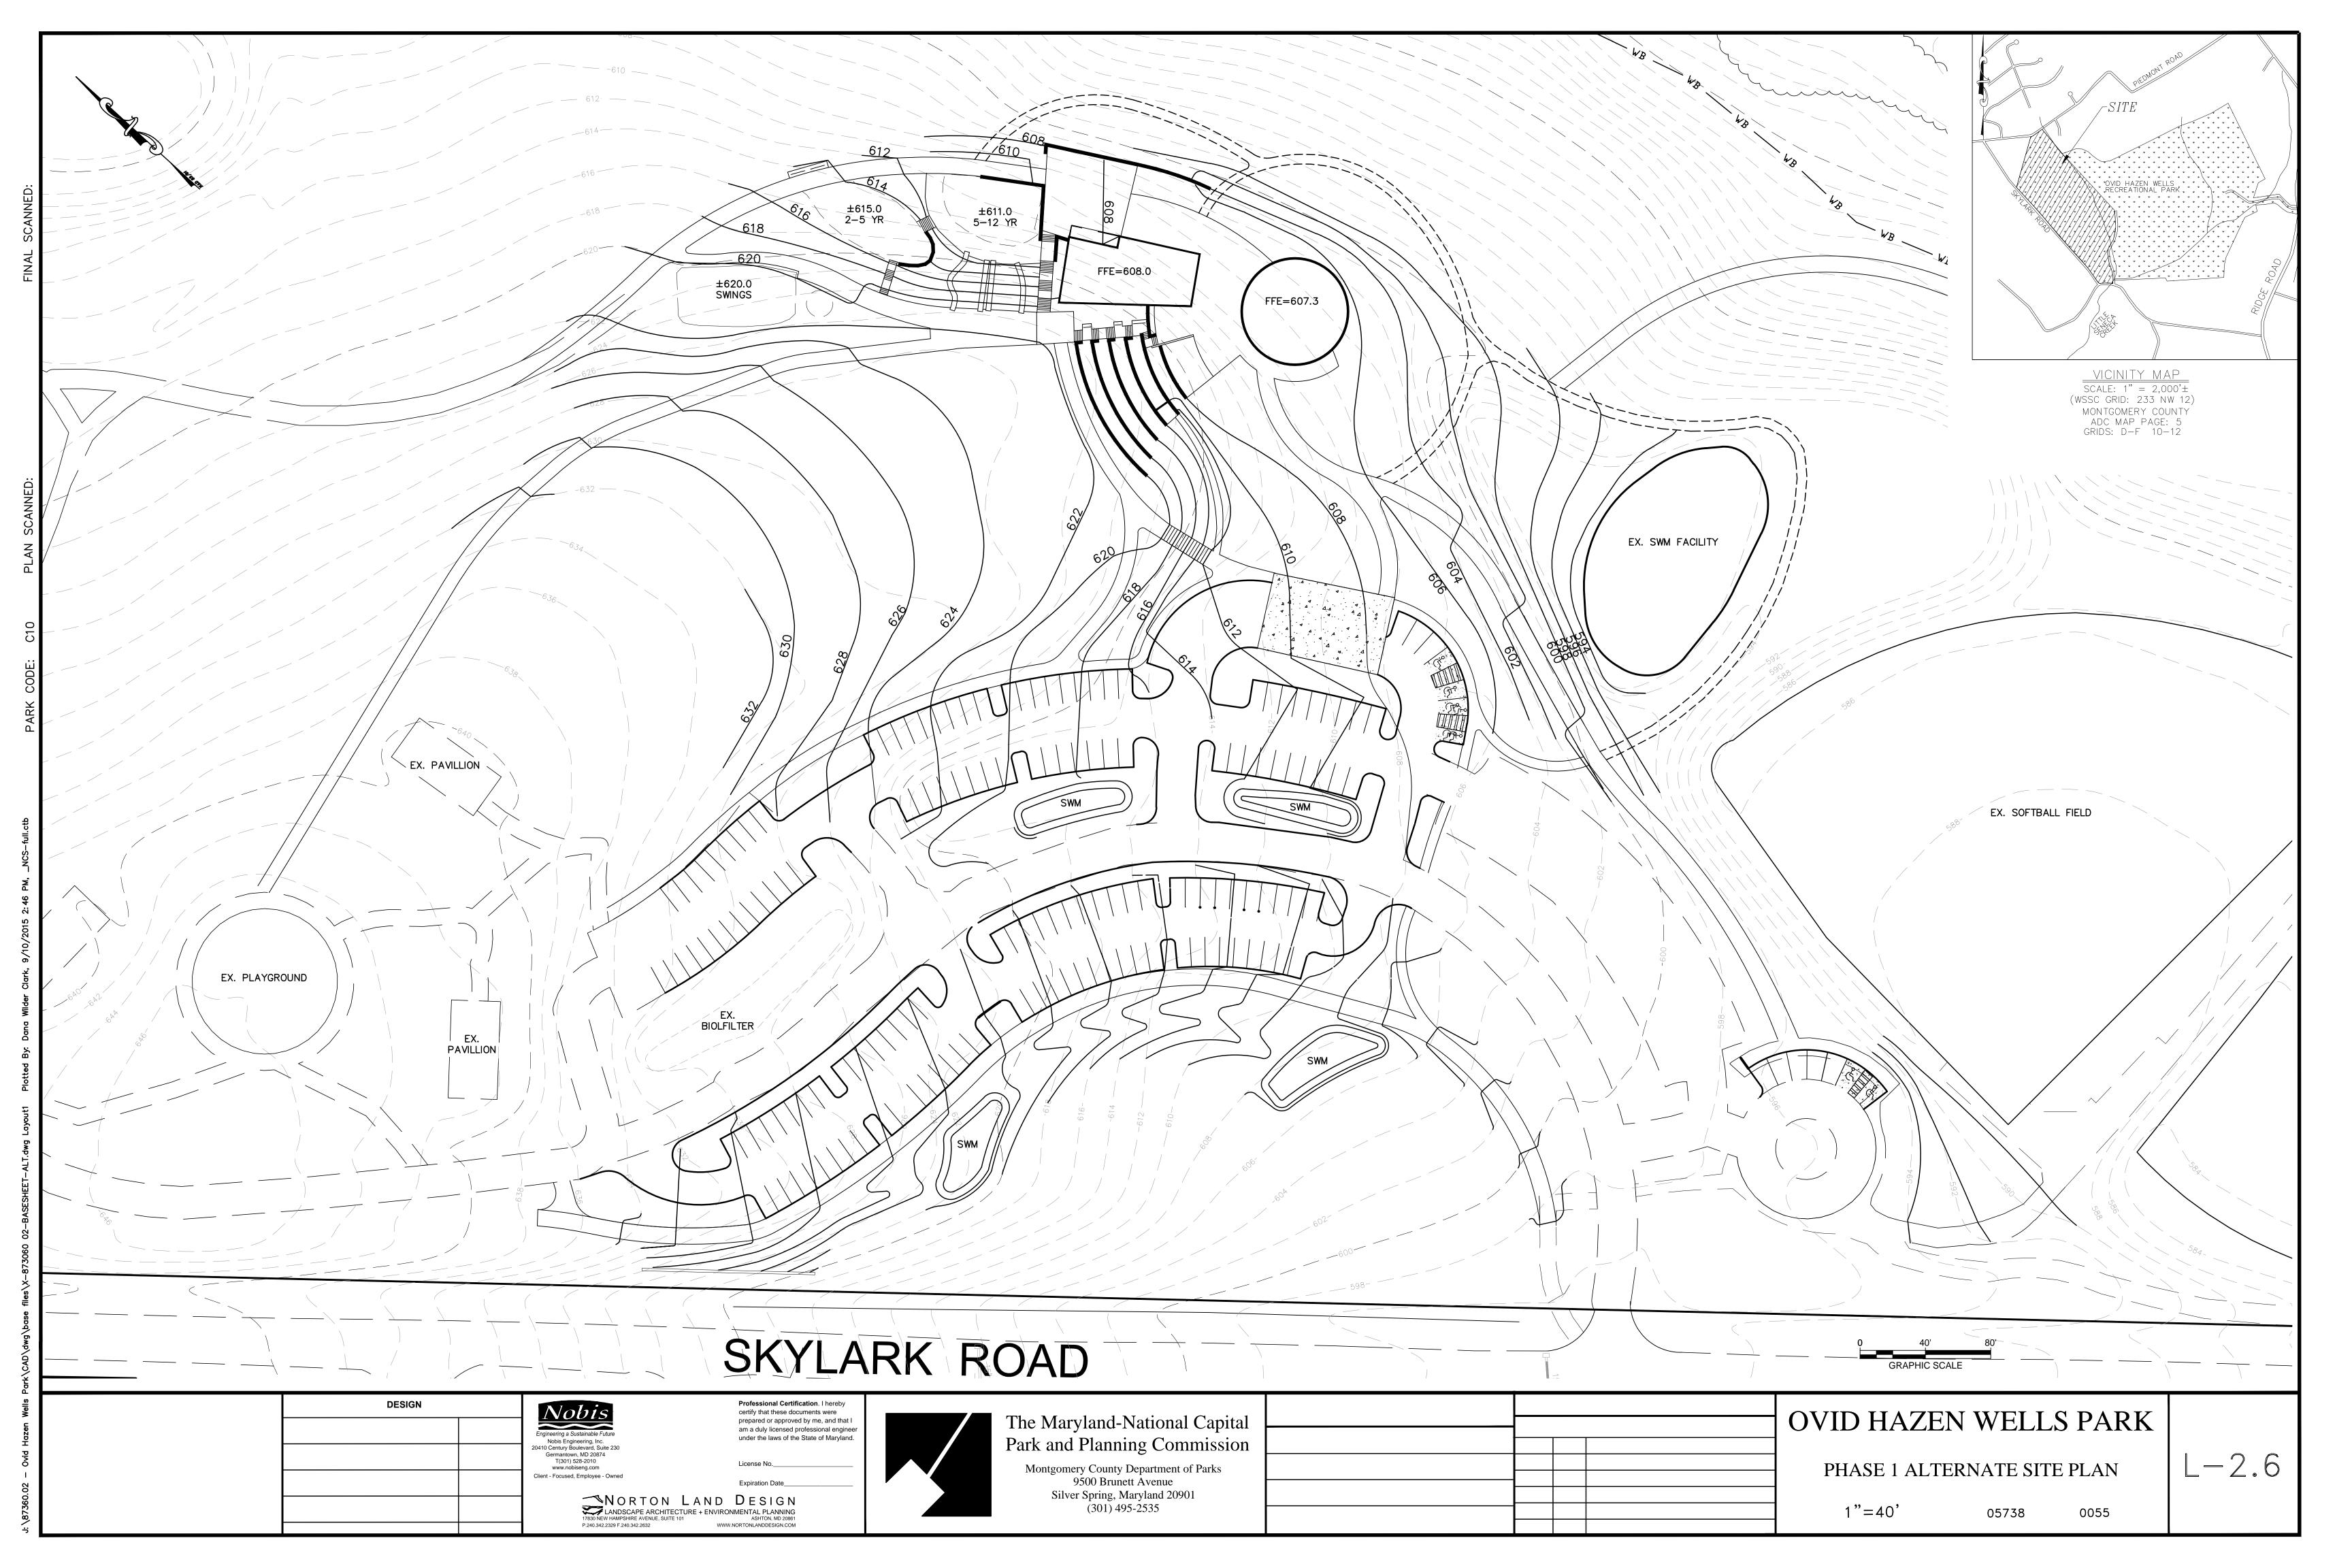


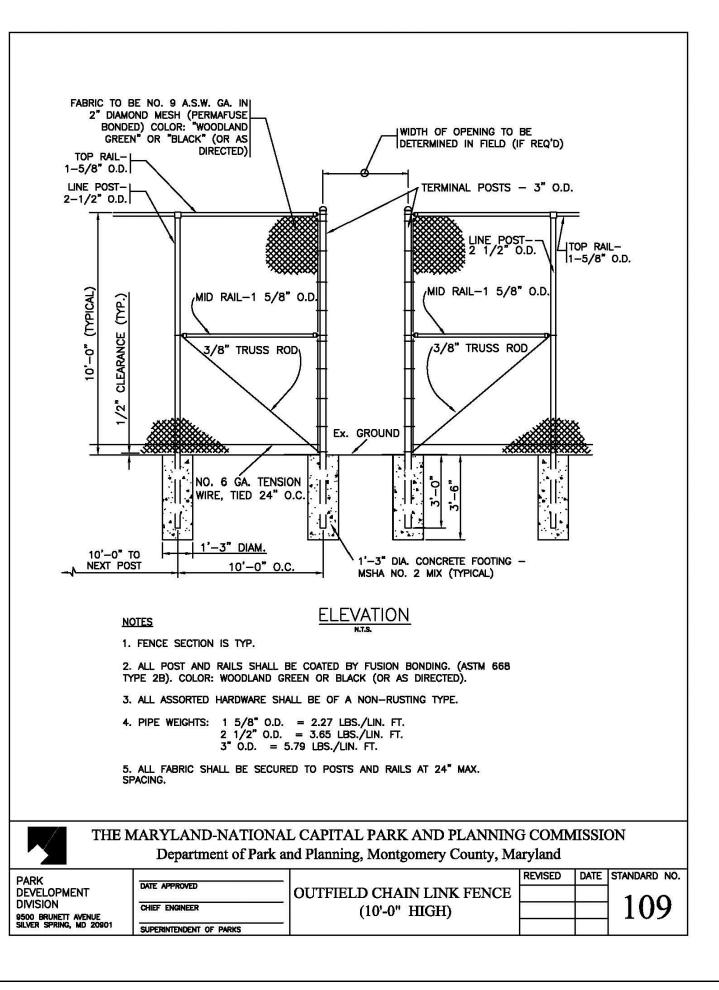


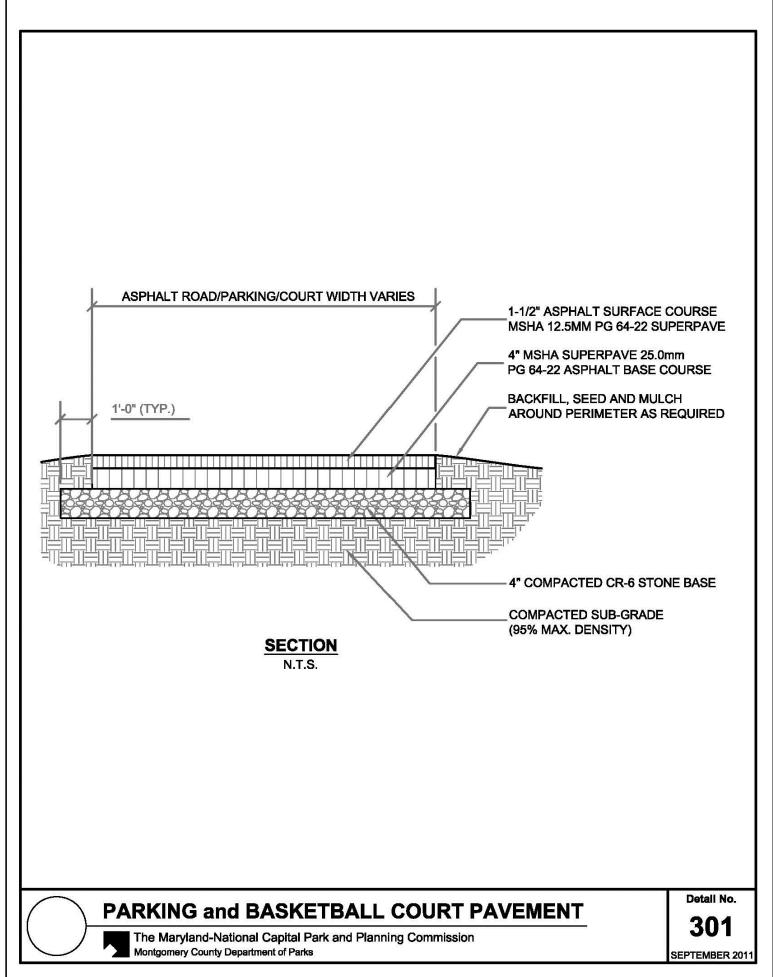


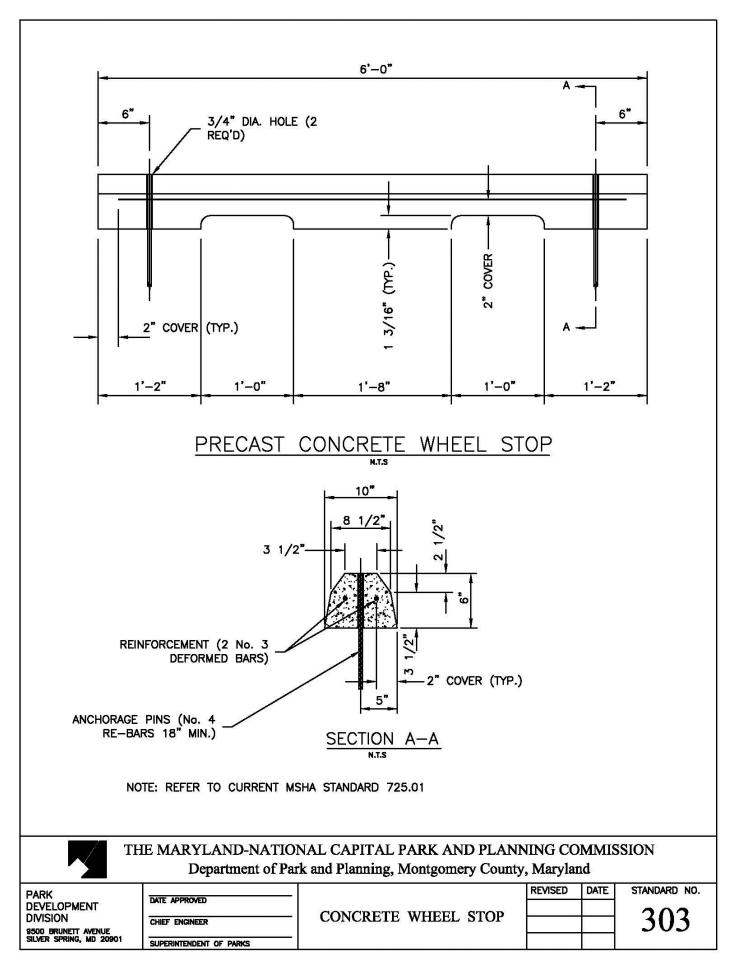


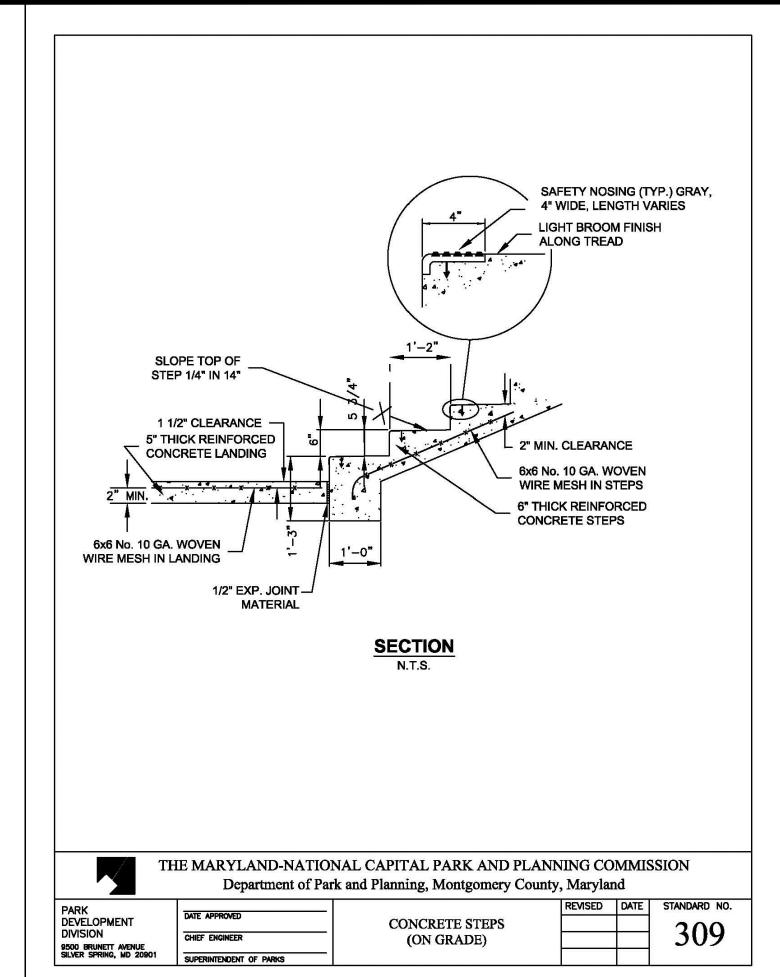


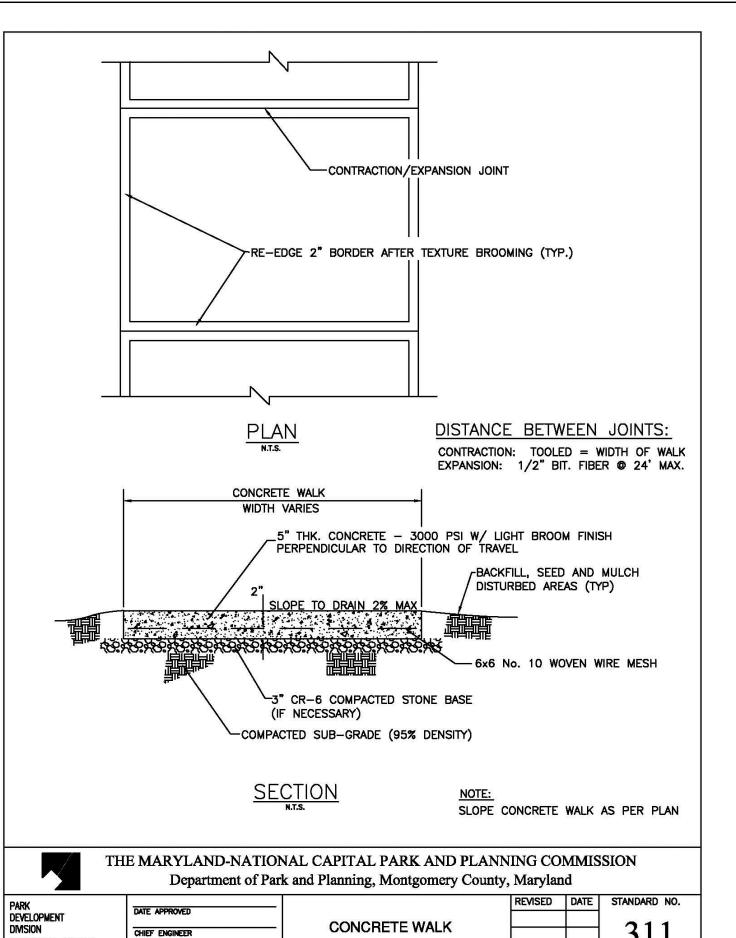

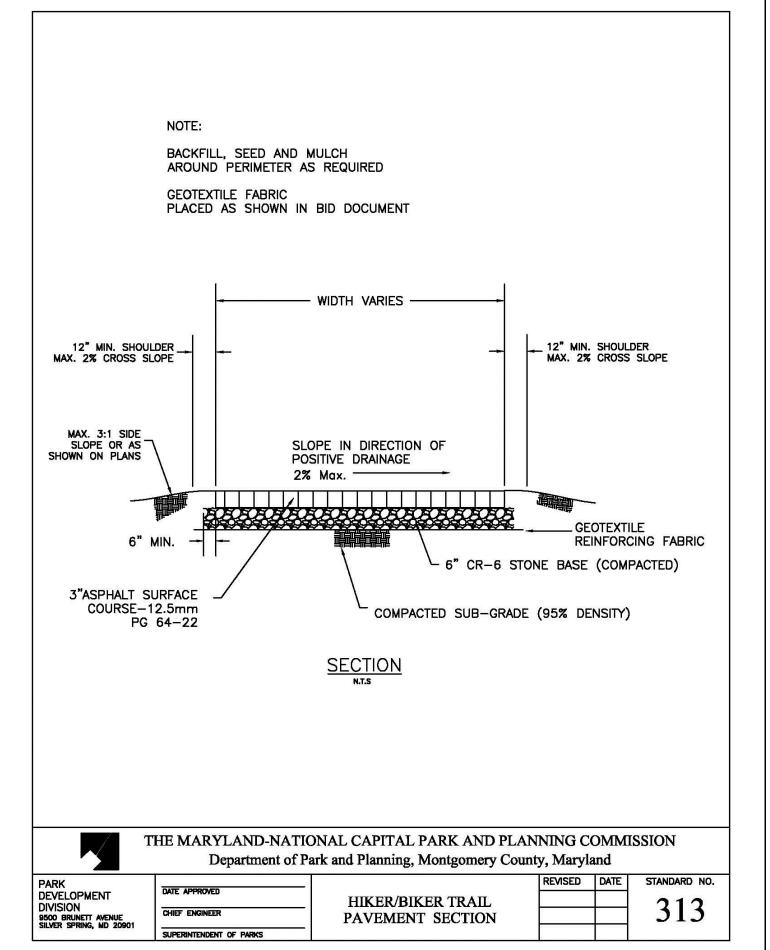

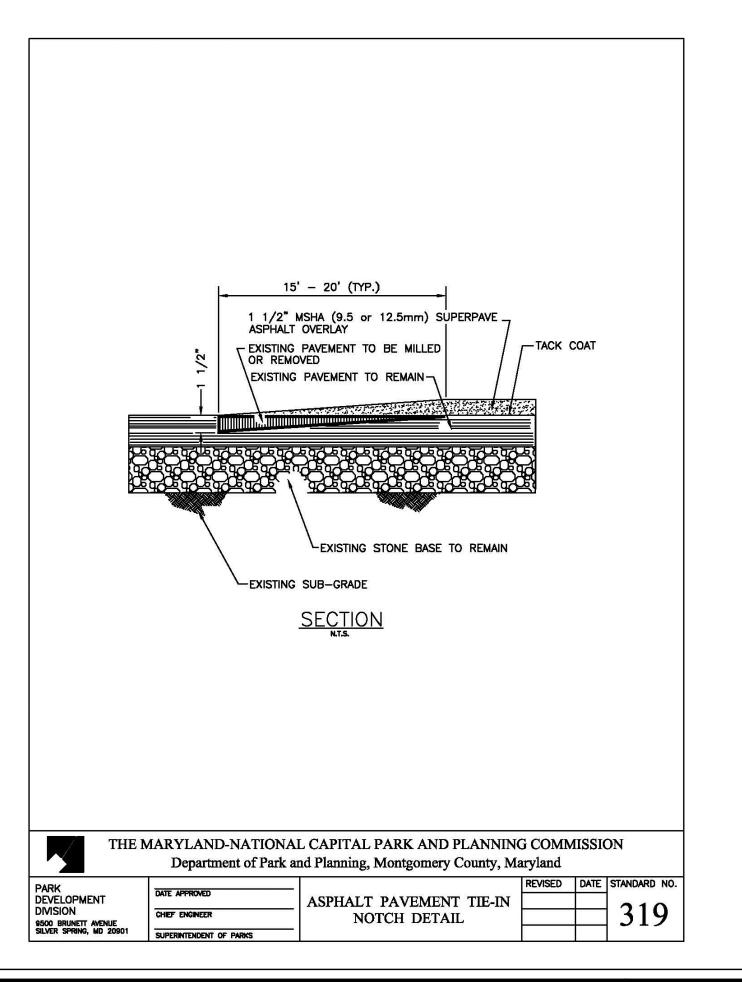

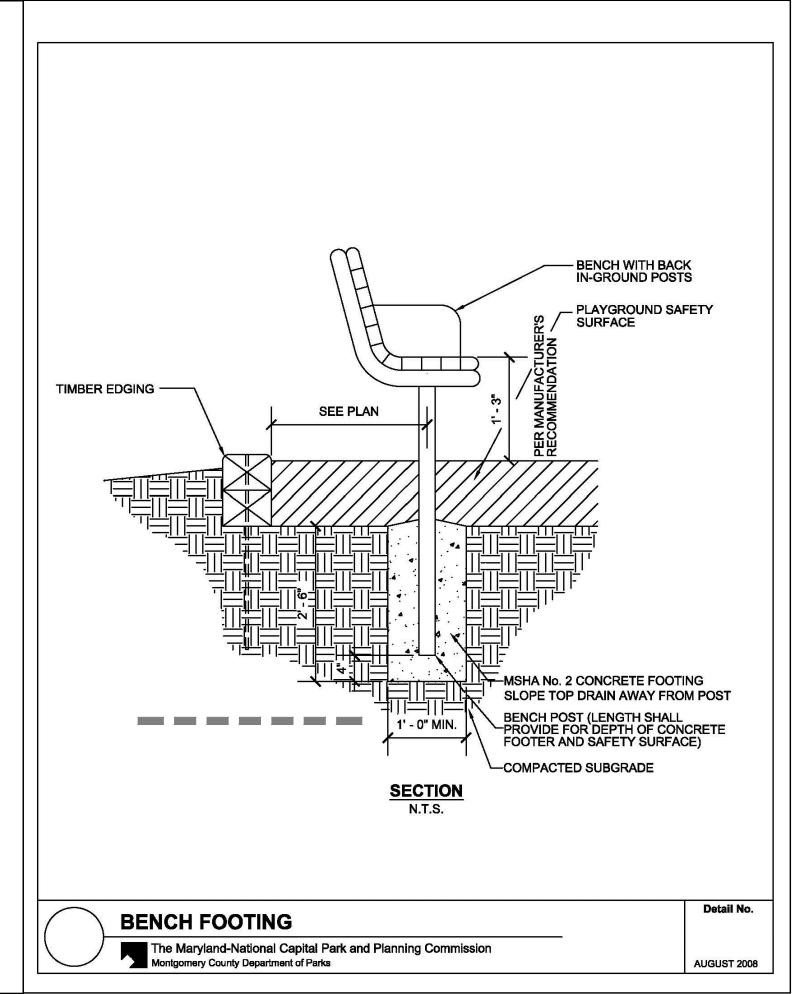

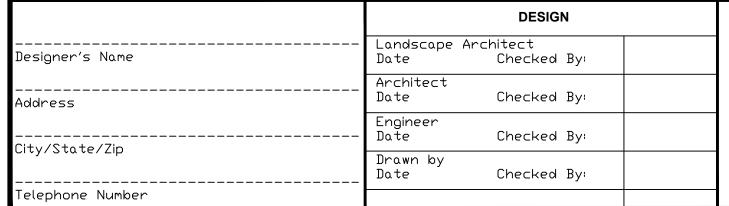

9500 BRUNETT AVENUE SILVER SPRING, MD 20901






REVIEW AND APPROVAL		FOR P	ROCUREMENT ON	 OVID HAZEN WELLS PAI		
			REVISIONS			
	Rev. No.	Date	Description	SITE NOTES		
Project Manager Date						
Construction Manager Date				AND DETAILS		
Park Manager Date				SCALE: AS SHOWN Liber 05738 Folio 0055		


OVID HAZEN WELLS PARK
SITE NOTES
AND DETAILS


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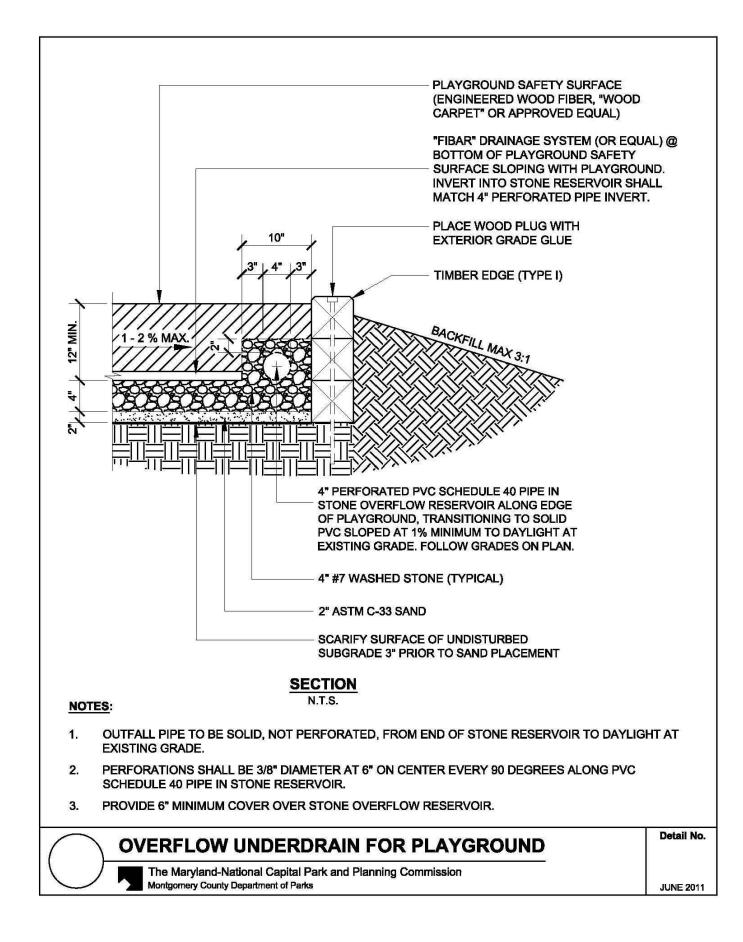


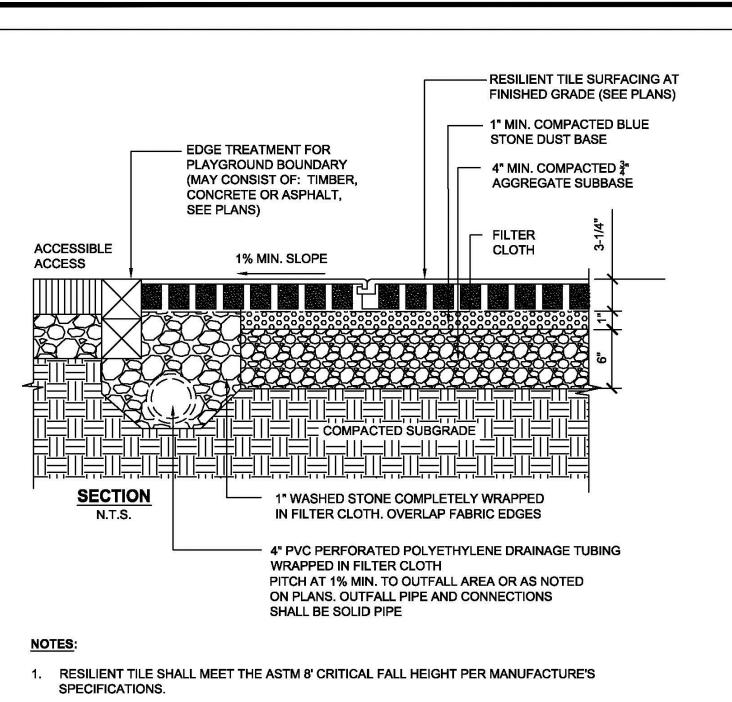
- APPLY ADHESIVE COAT TO ENTIRE SURFACE PRIOR TO INSTALLING RESILIENT TILES; AND APPLY ADHESIVE TO EACH JOINT PER MANUFACTURE'S SPECIFICATIONS.
- 3. ENSURE SUBSOIL DRAINS TOWARDS PERFORATED DRAIN TUBING.
- INSTALLPERFORATED DRAIN TILE AT 16" ON CENTER AS WELL AS AROUND THE PERIMETER OF RESILIENT TILE INSTALLATION.
- BACK FILL AROUND PERFORATED DRAIN TILE WITH 1" WASHED STONE TO 6" RADIUS AROUND DRAIN TUBING. WRAP WITH FILTER CLOTH TO PERVENT THE STONE FROM OBSTRUCTING THE DRAIN.






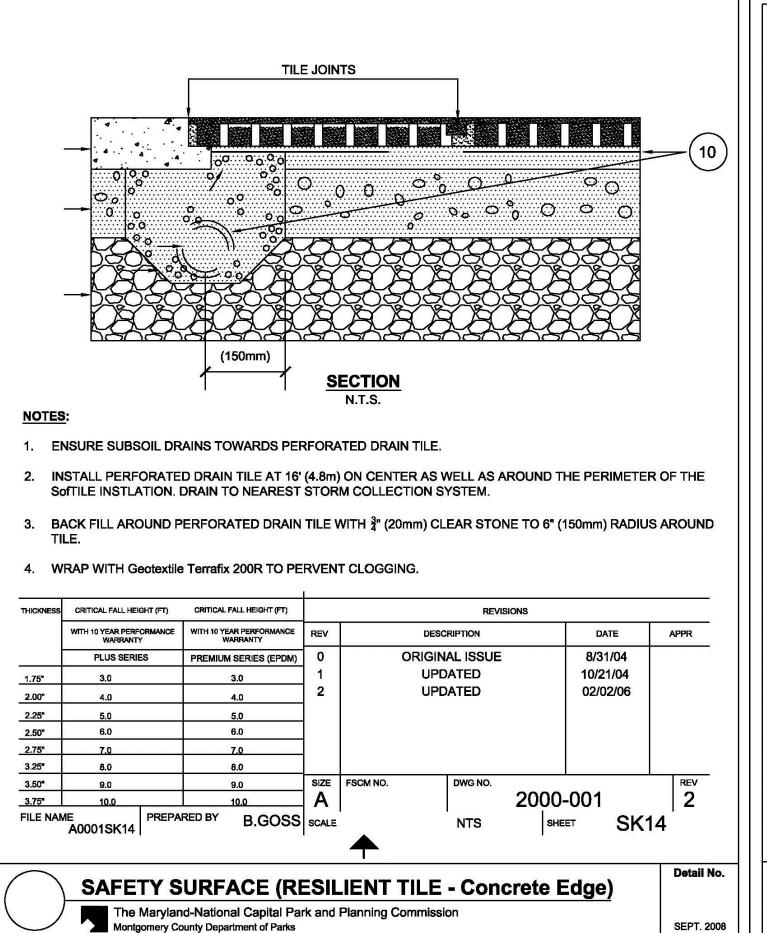

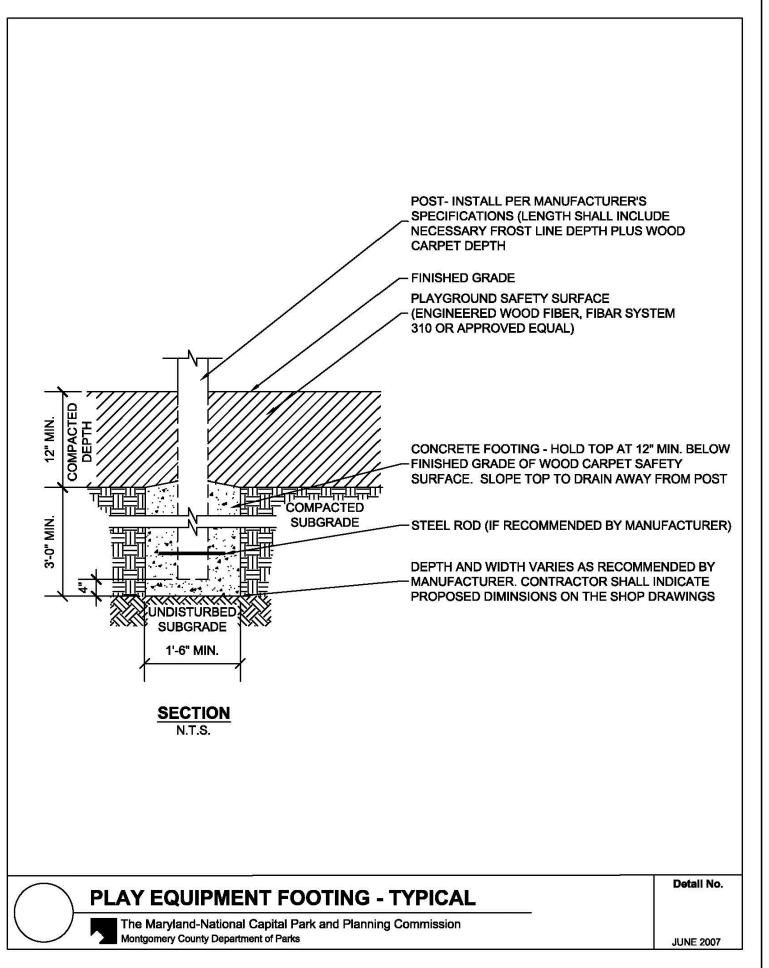

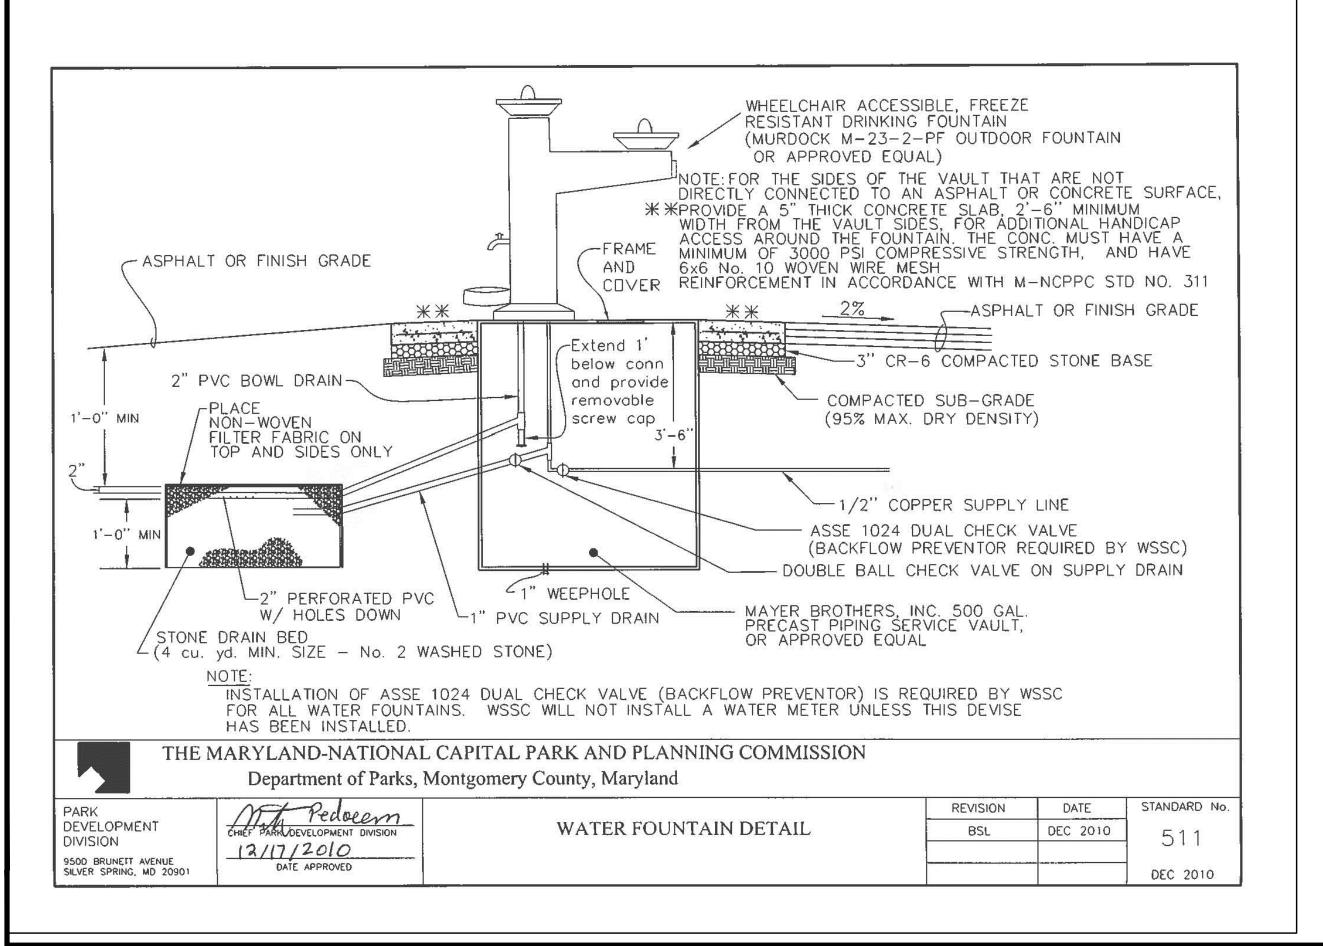

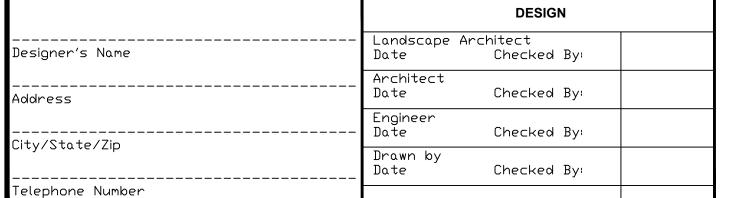

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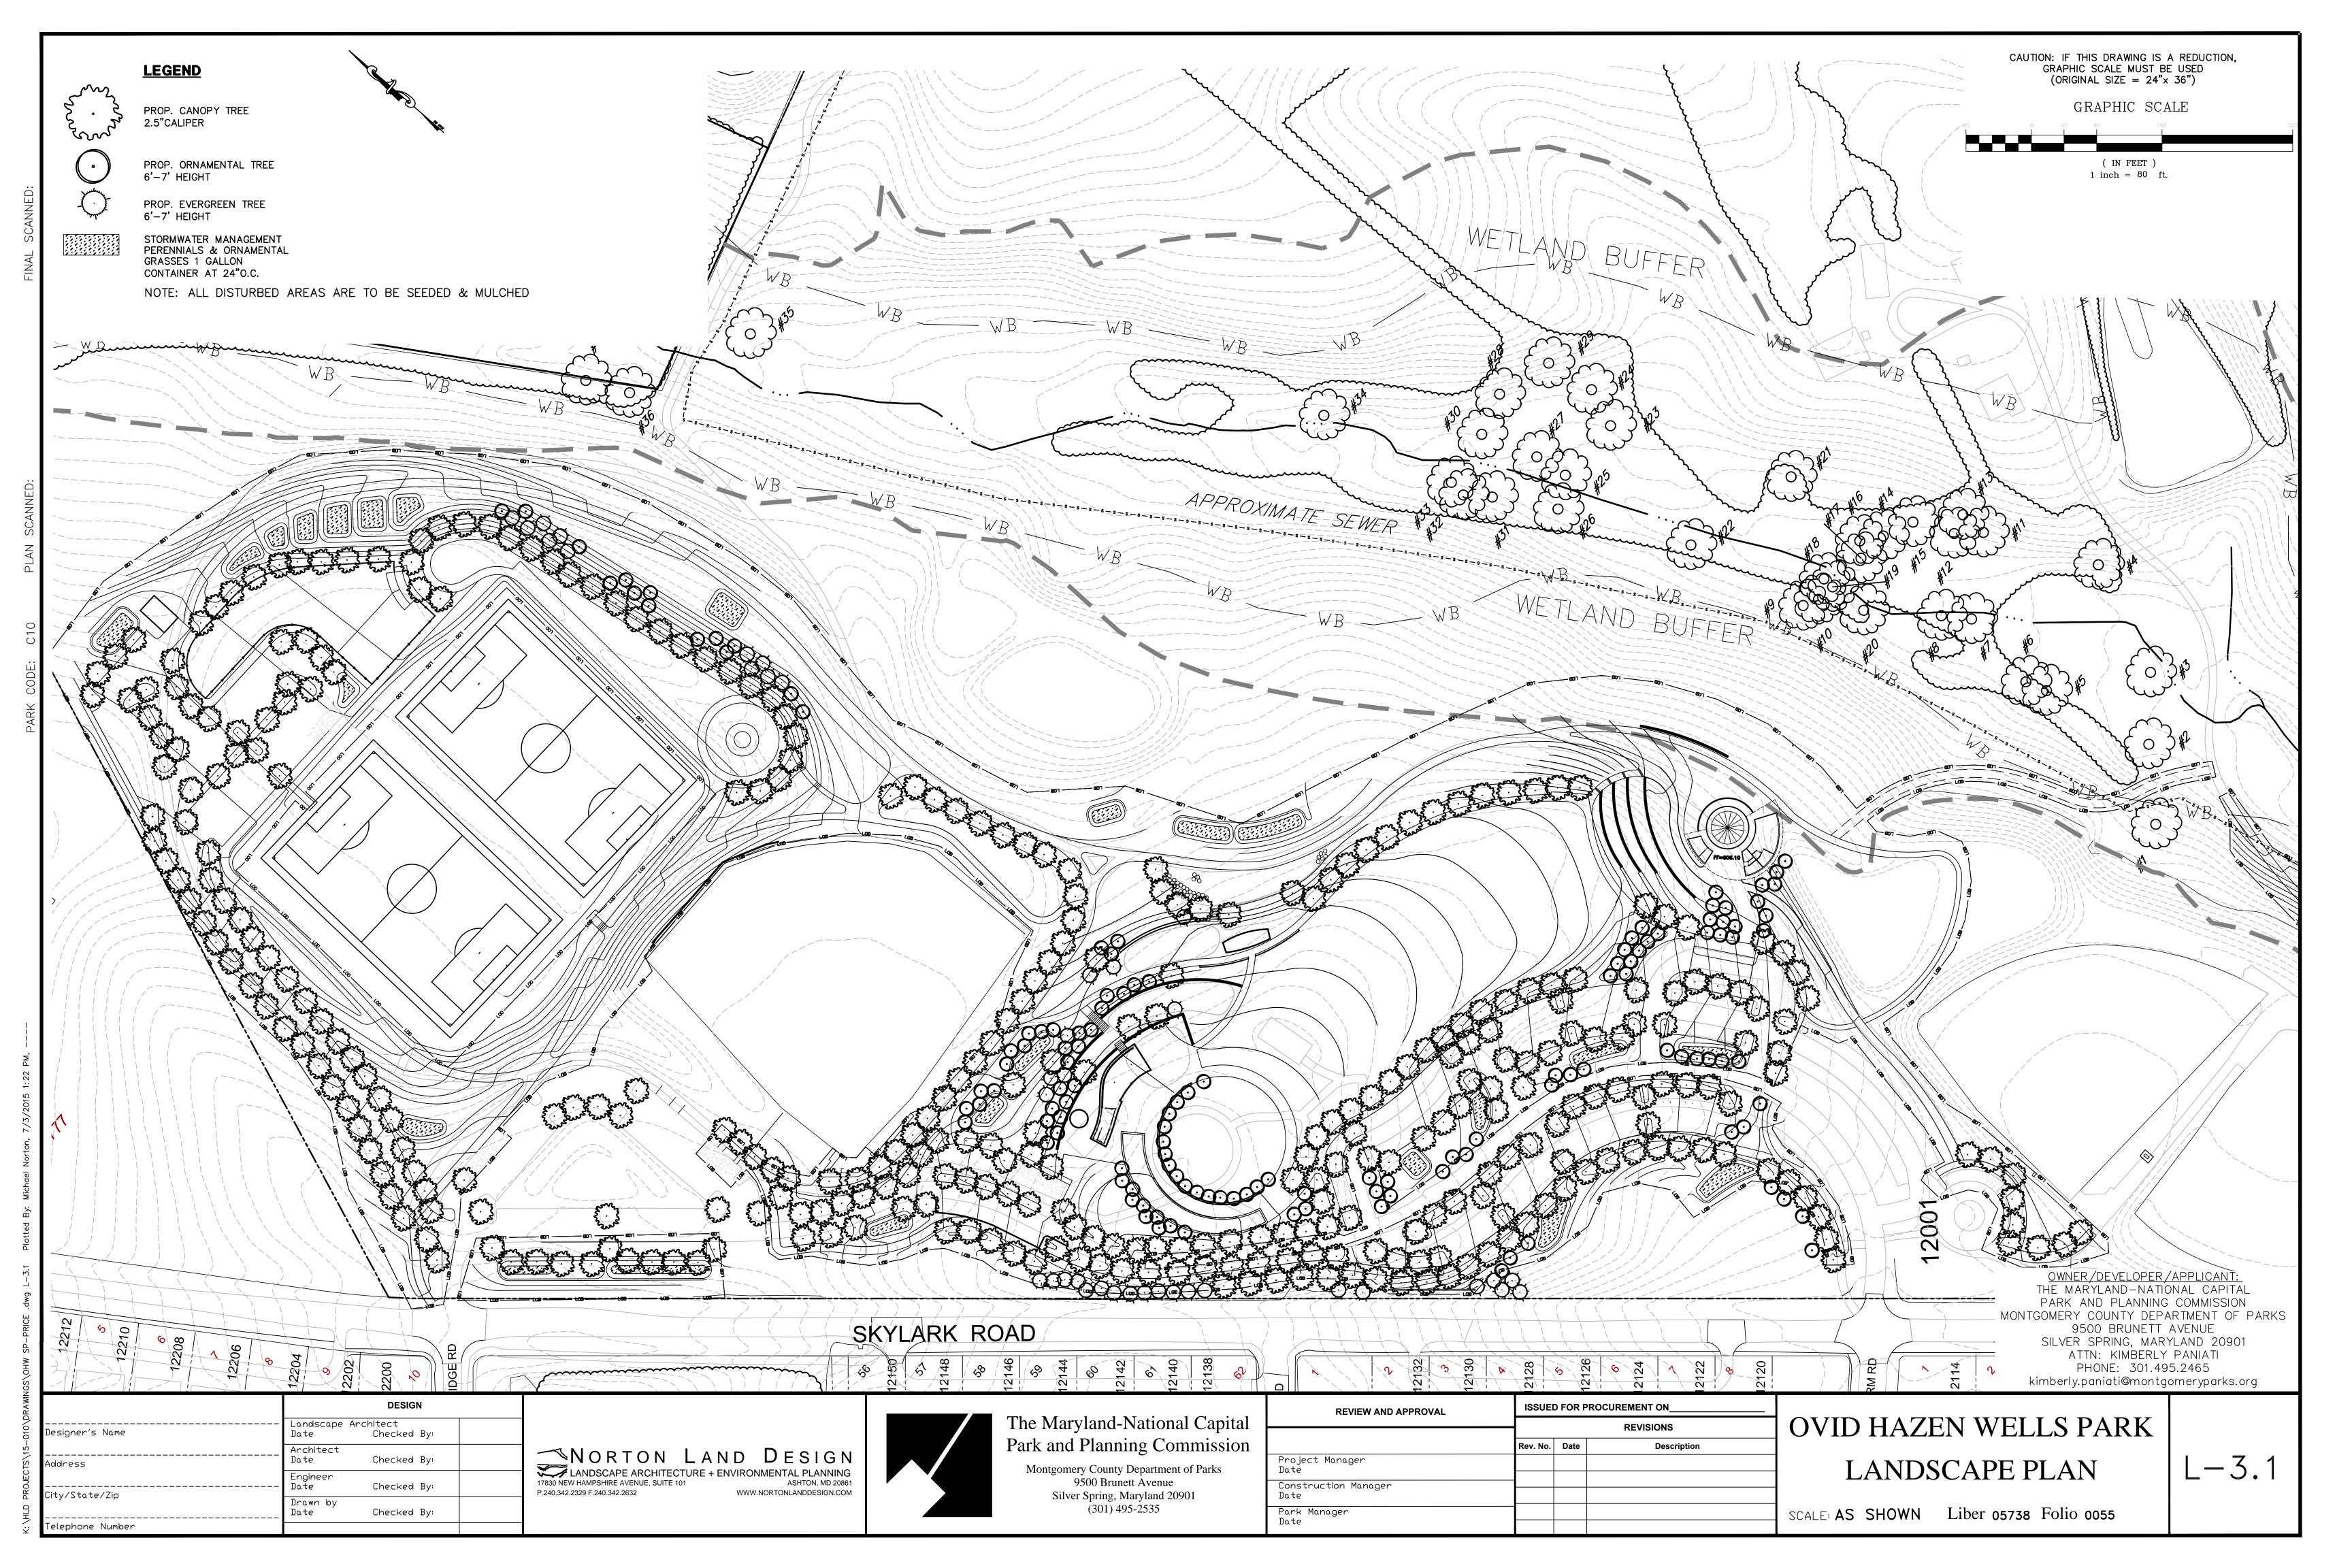



The Maryland-National Capital Park and Planning Commission


Montgomery County Department of Parks 9500 Brunett Avenue Silver Spring, Maryland 20901 (301) 495-2535


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	Construction Manager Date				AND DETAILS		
	Park Manager Date				SCALE: AS SHOWN Liber 05738 Folio 0055		


OVID HAZEN WELLS PARK SITE NOTES AND DETAILS




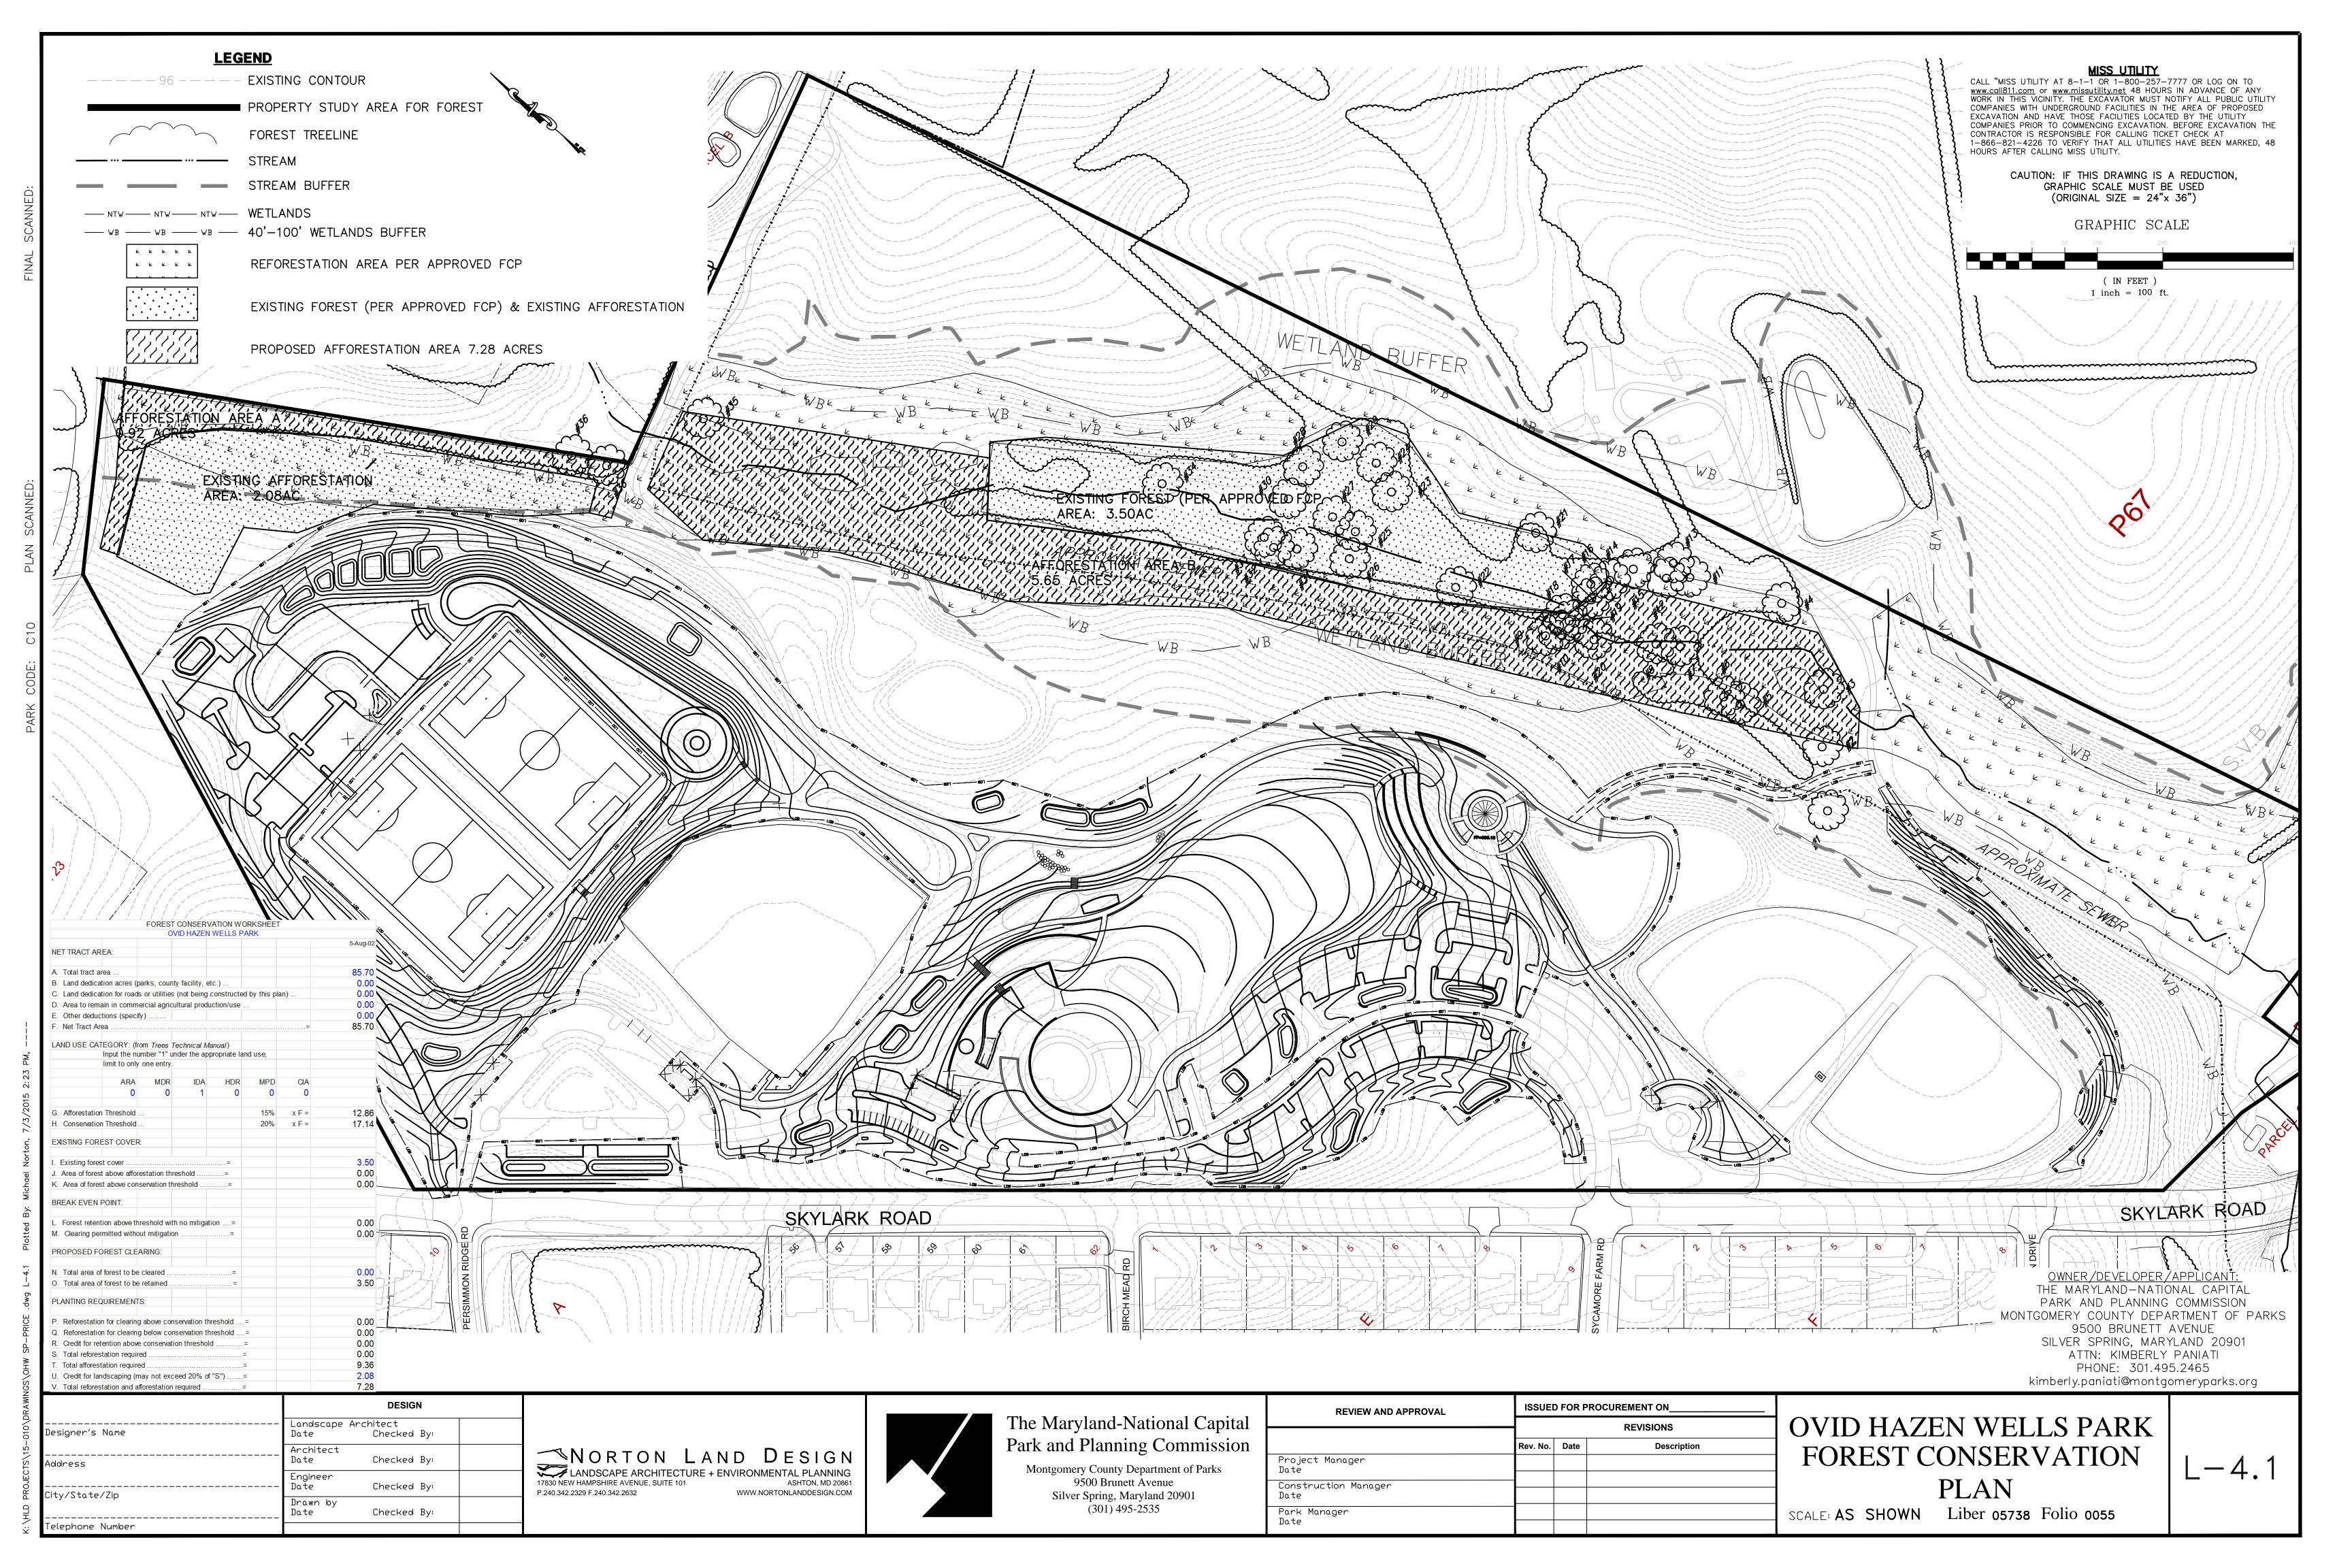


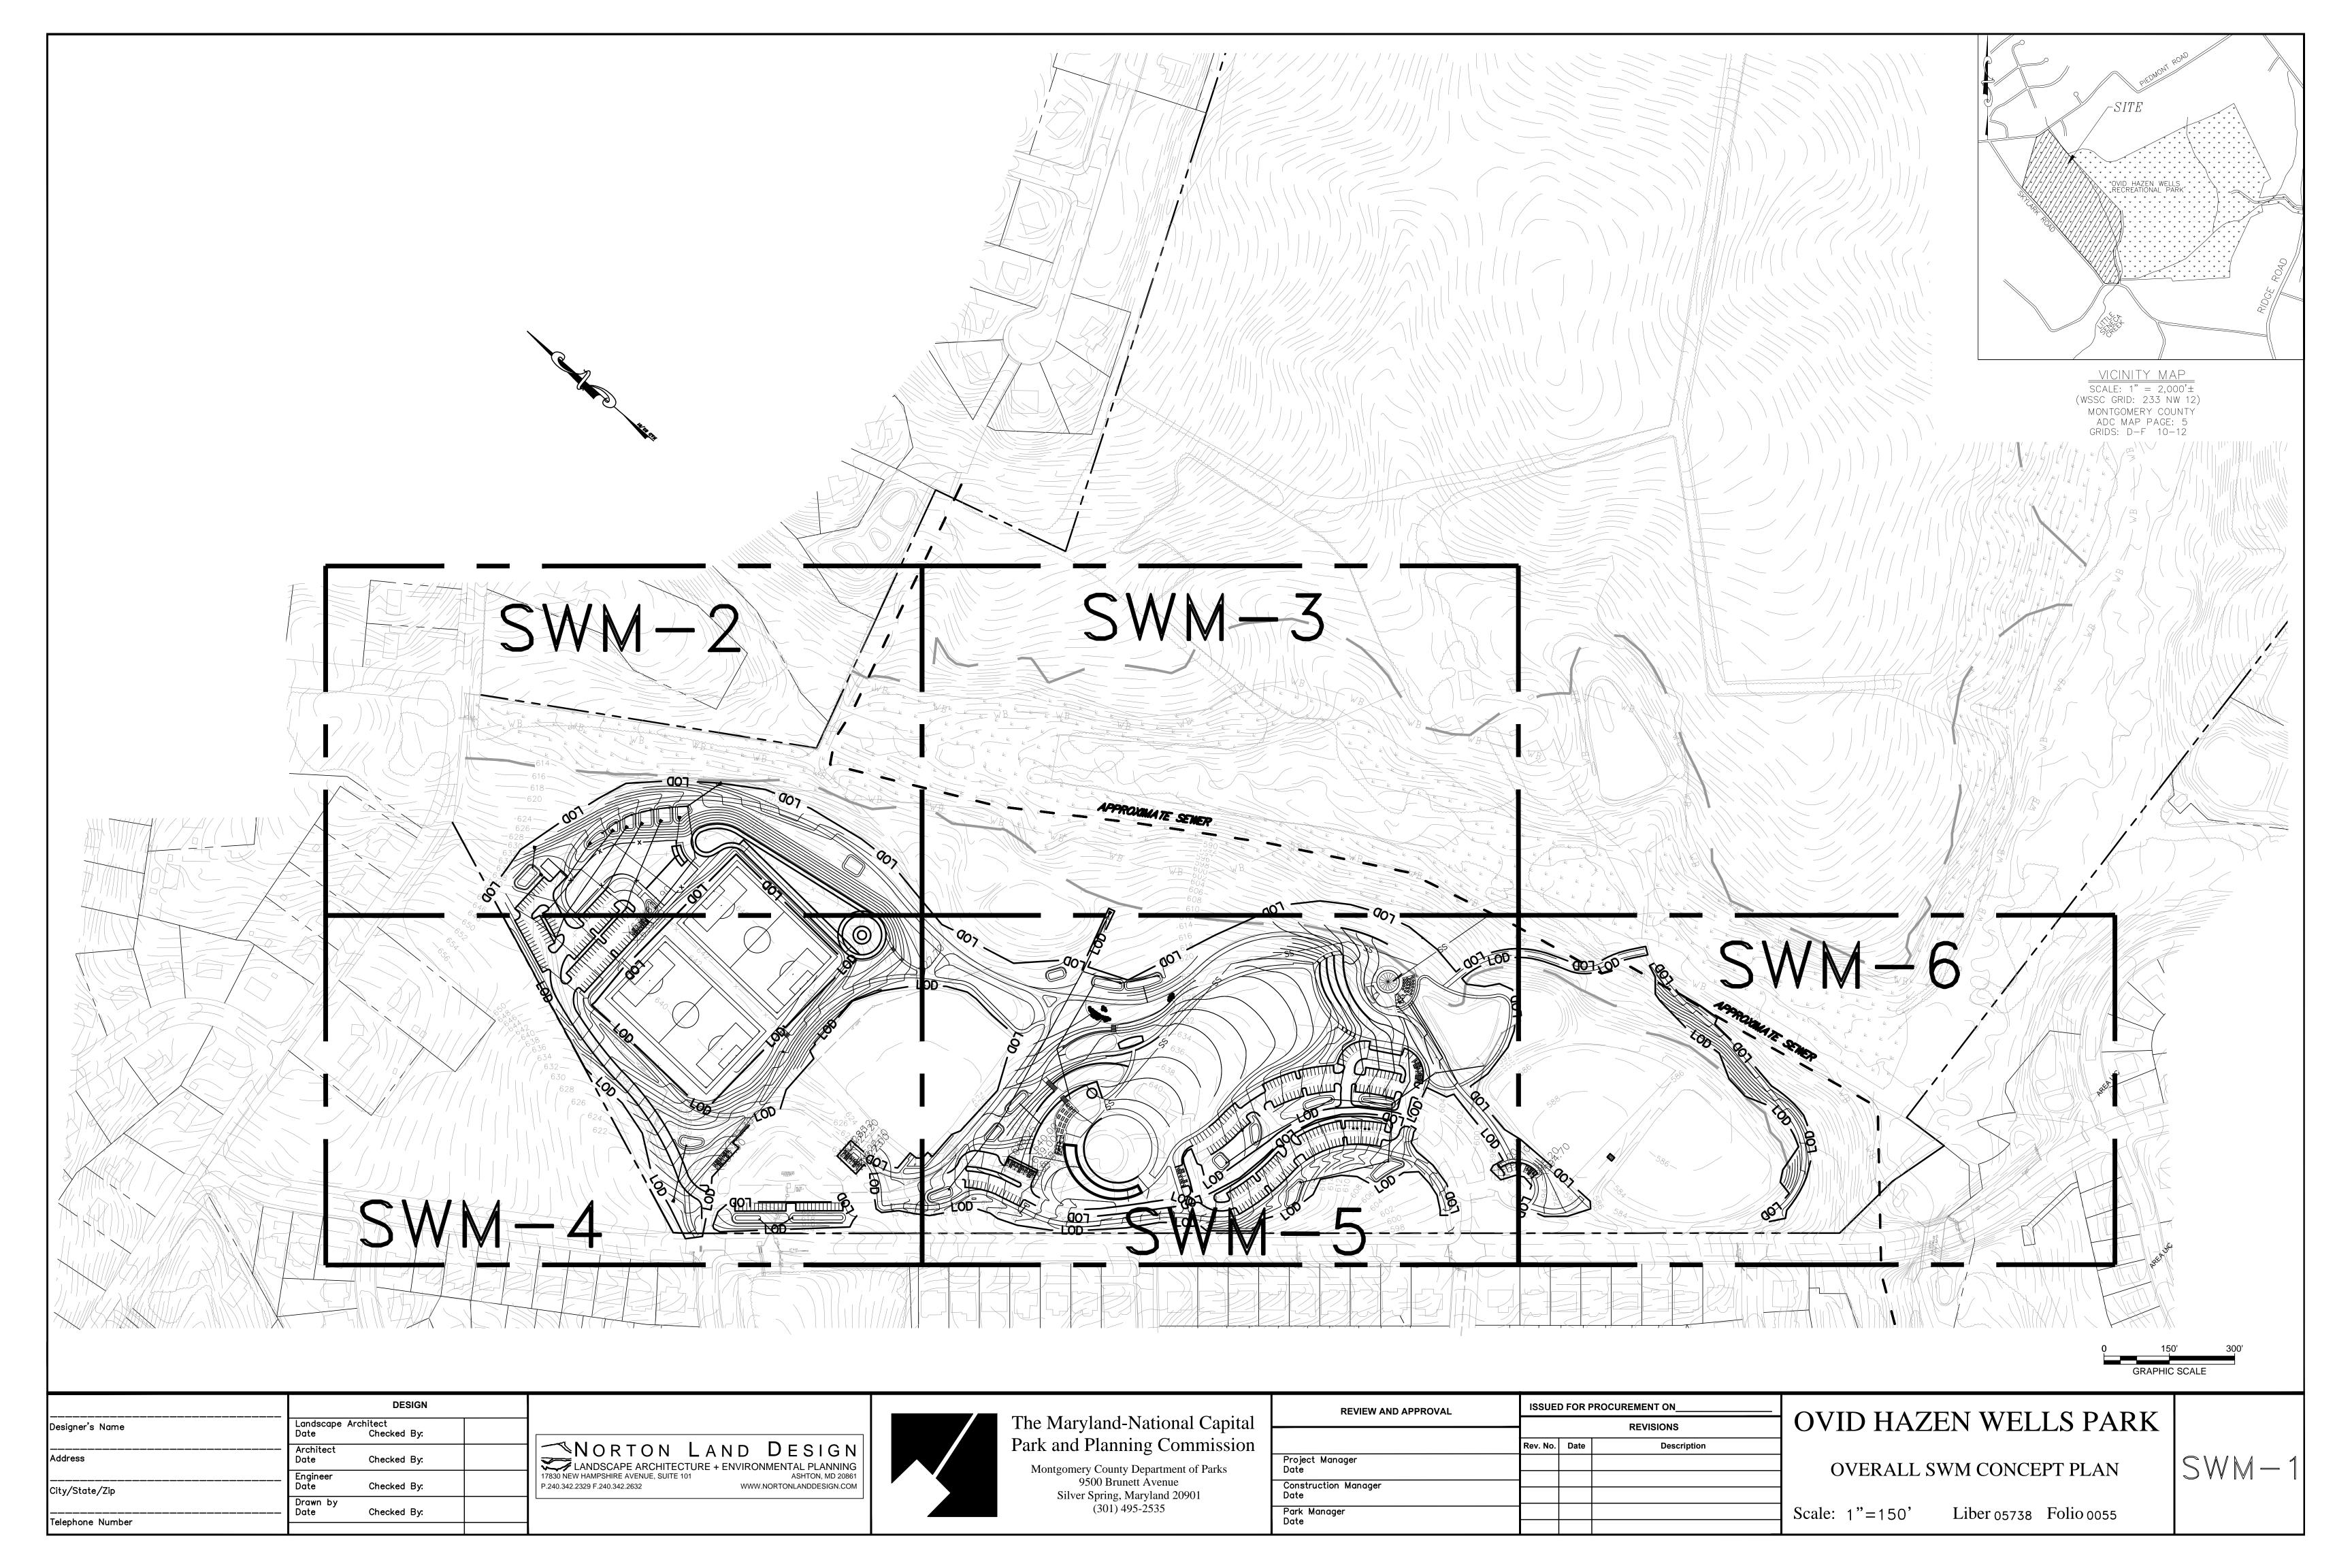


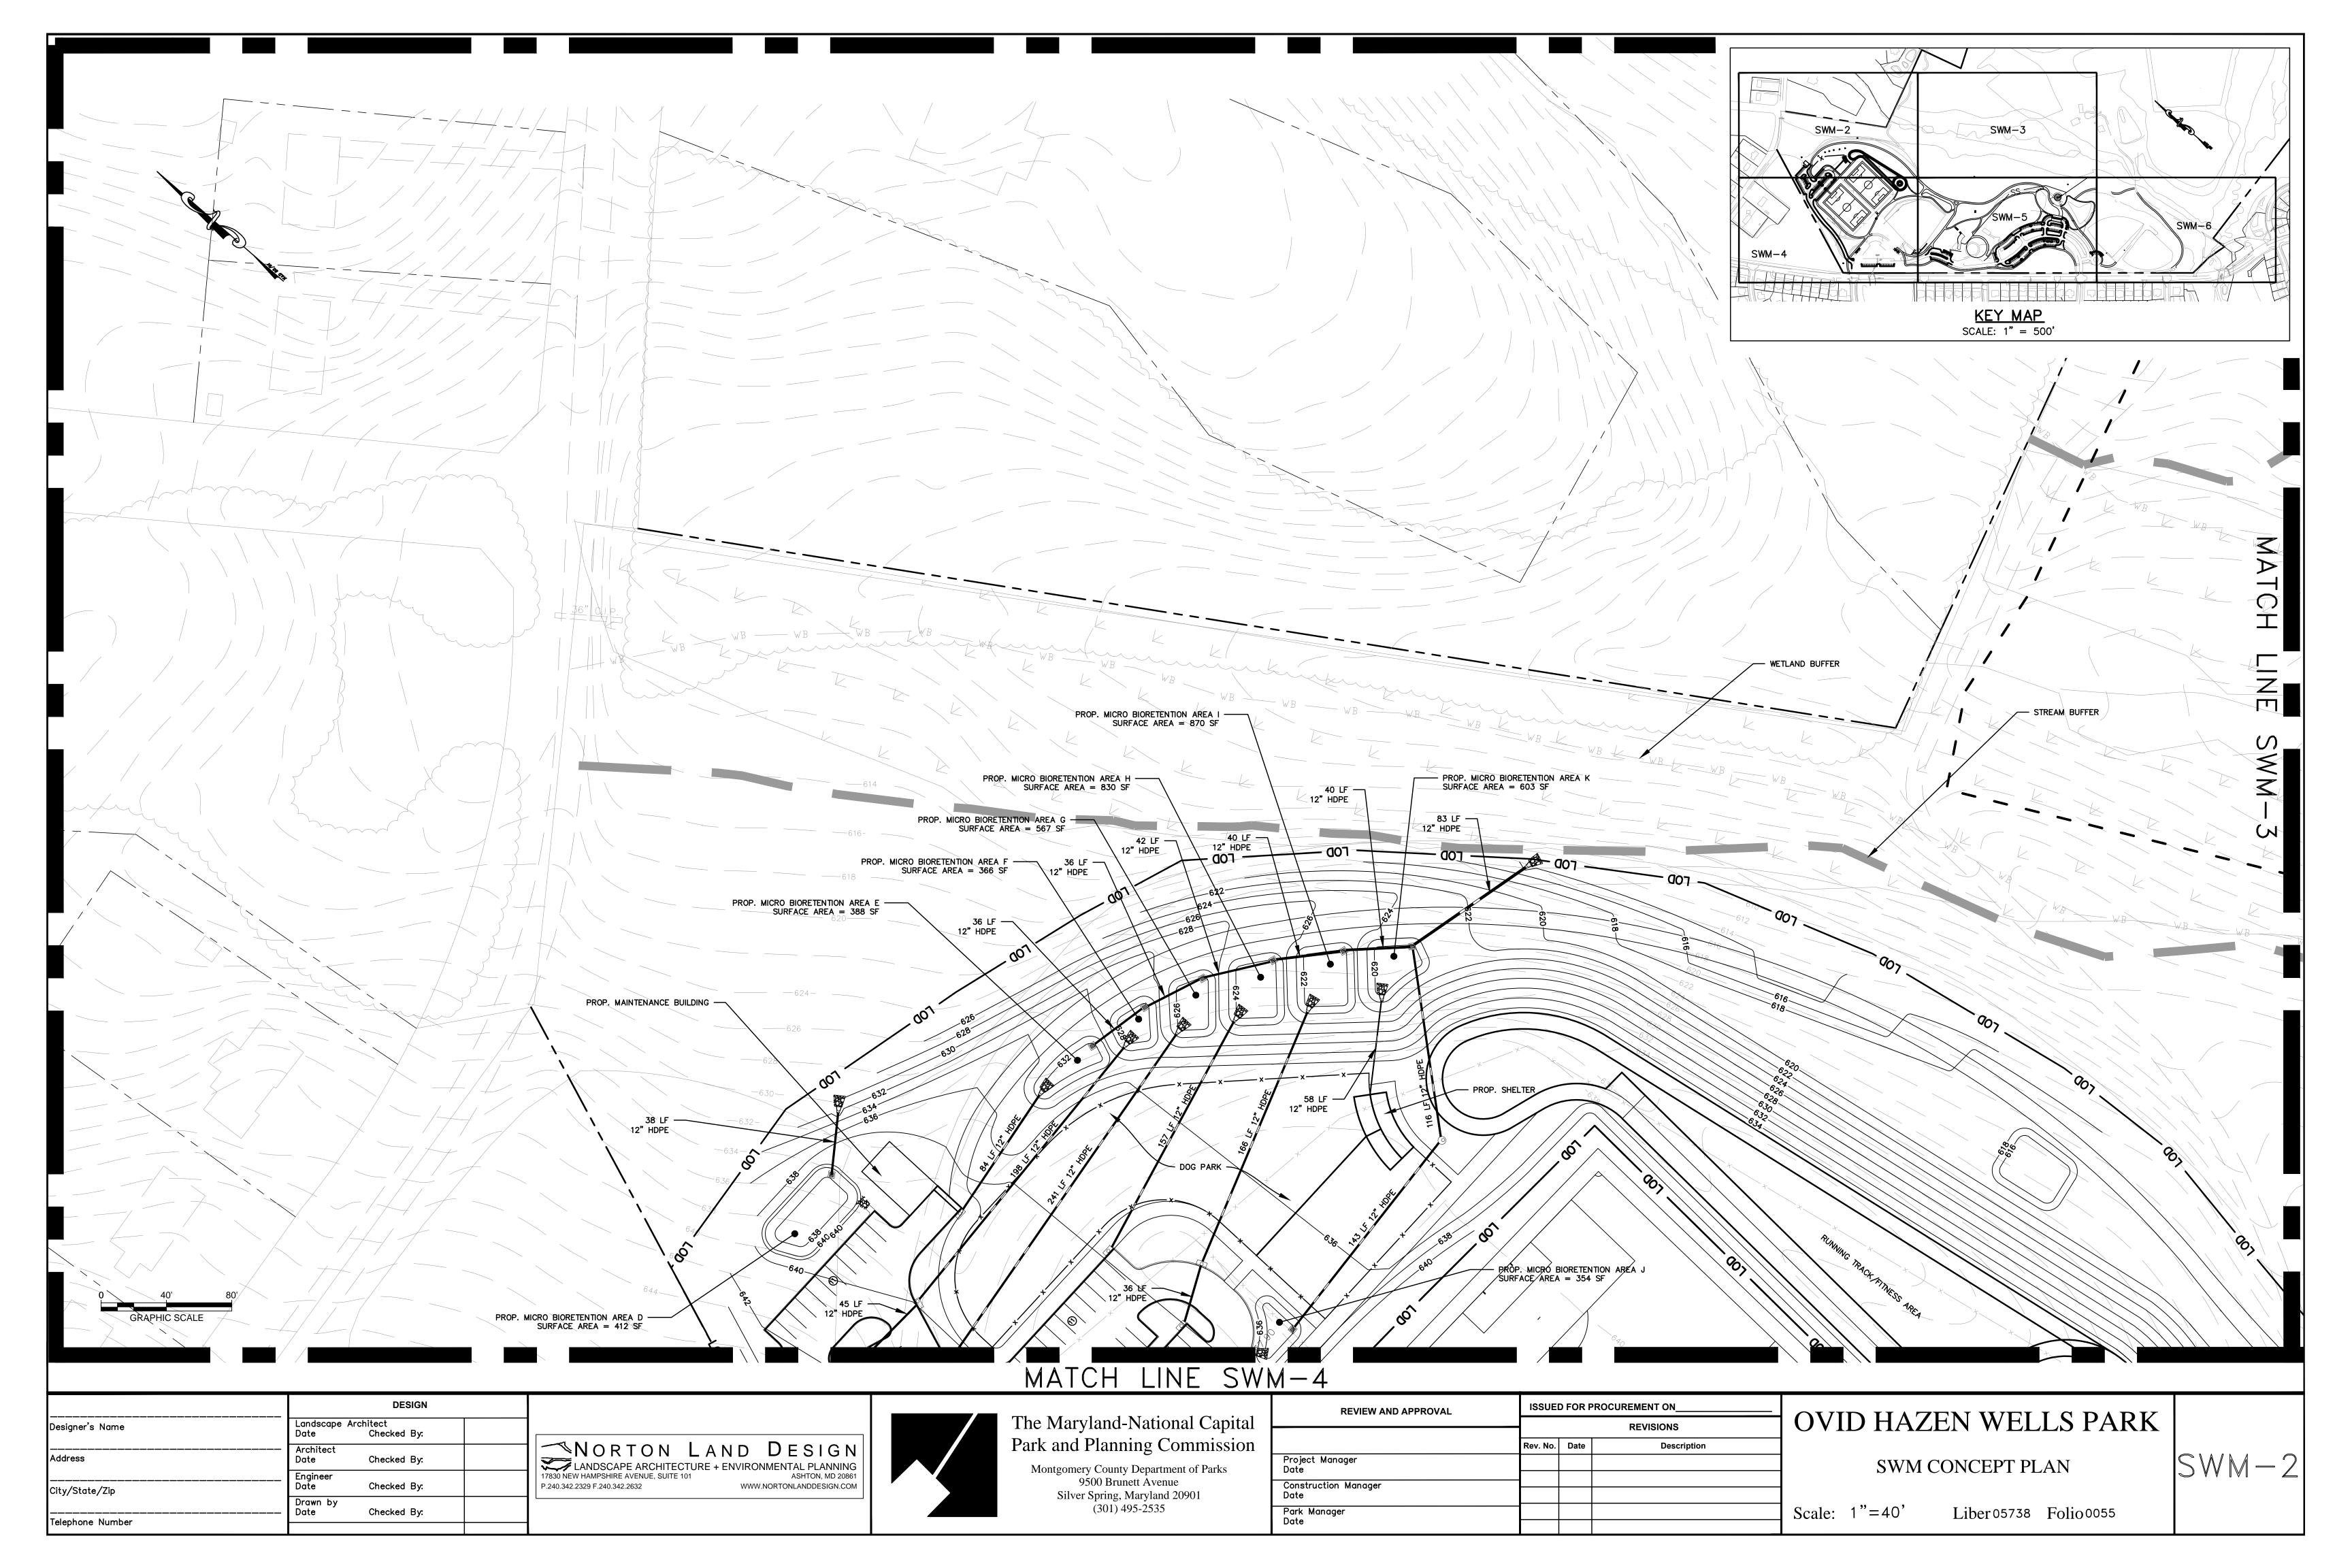


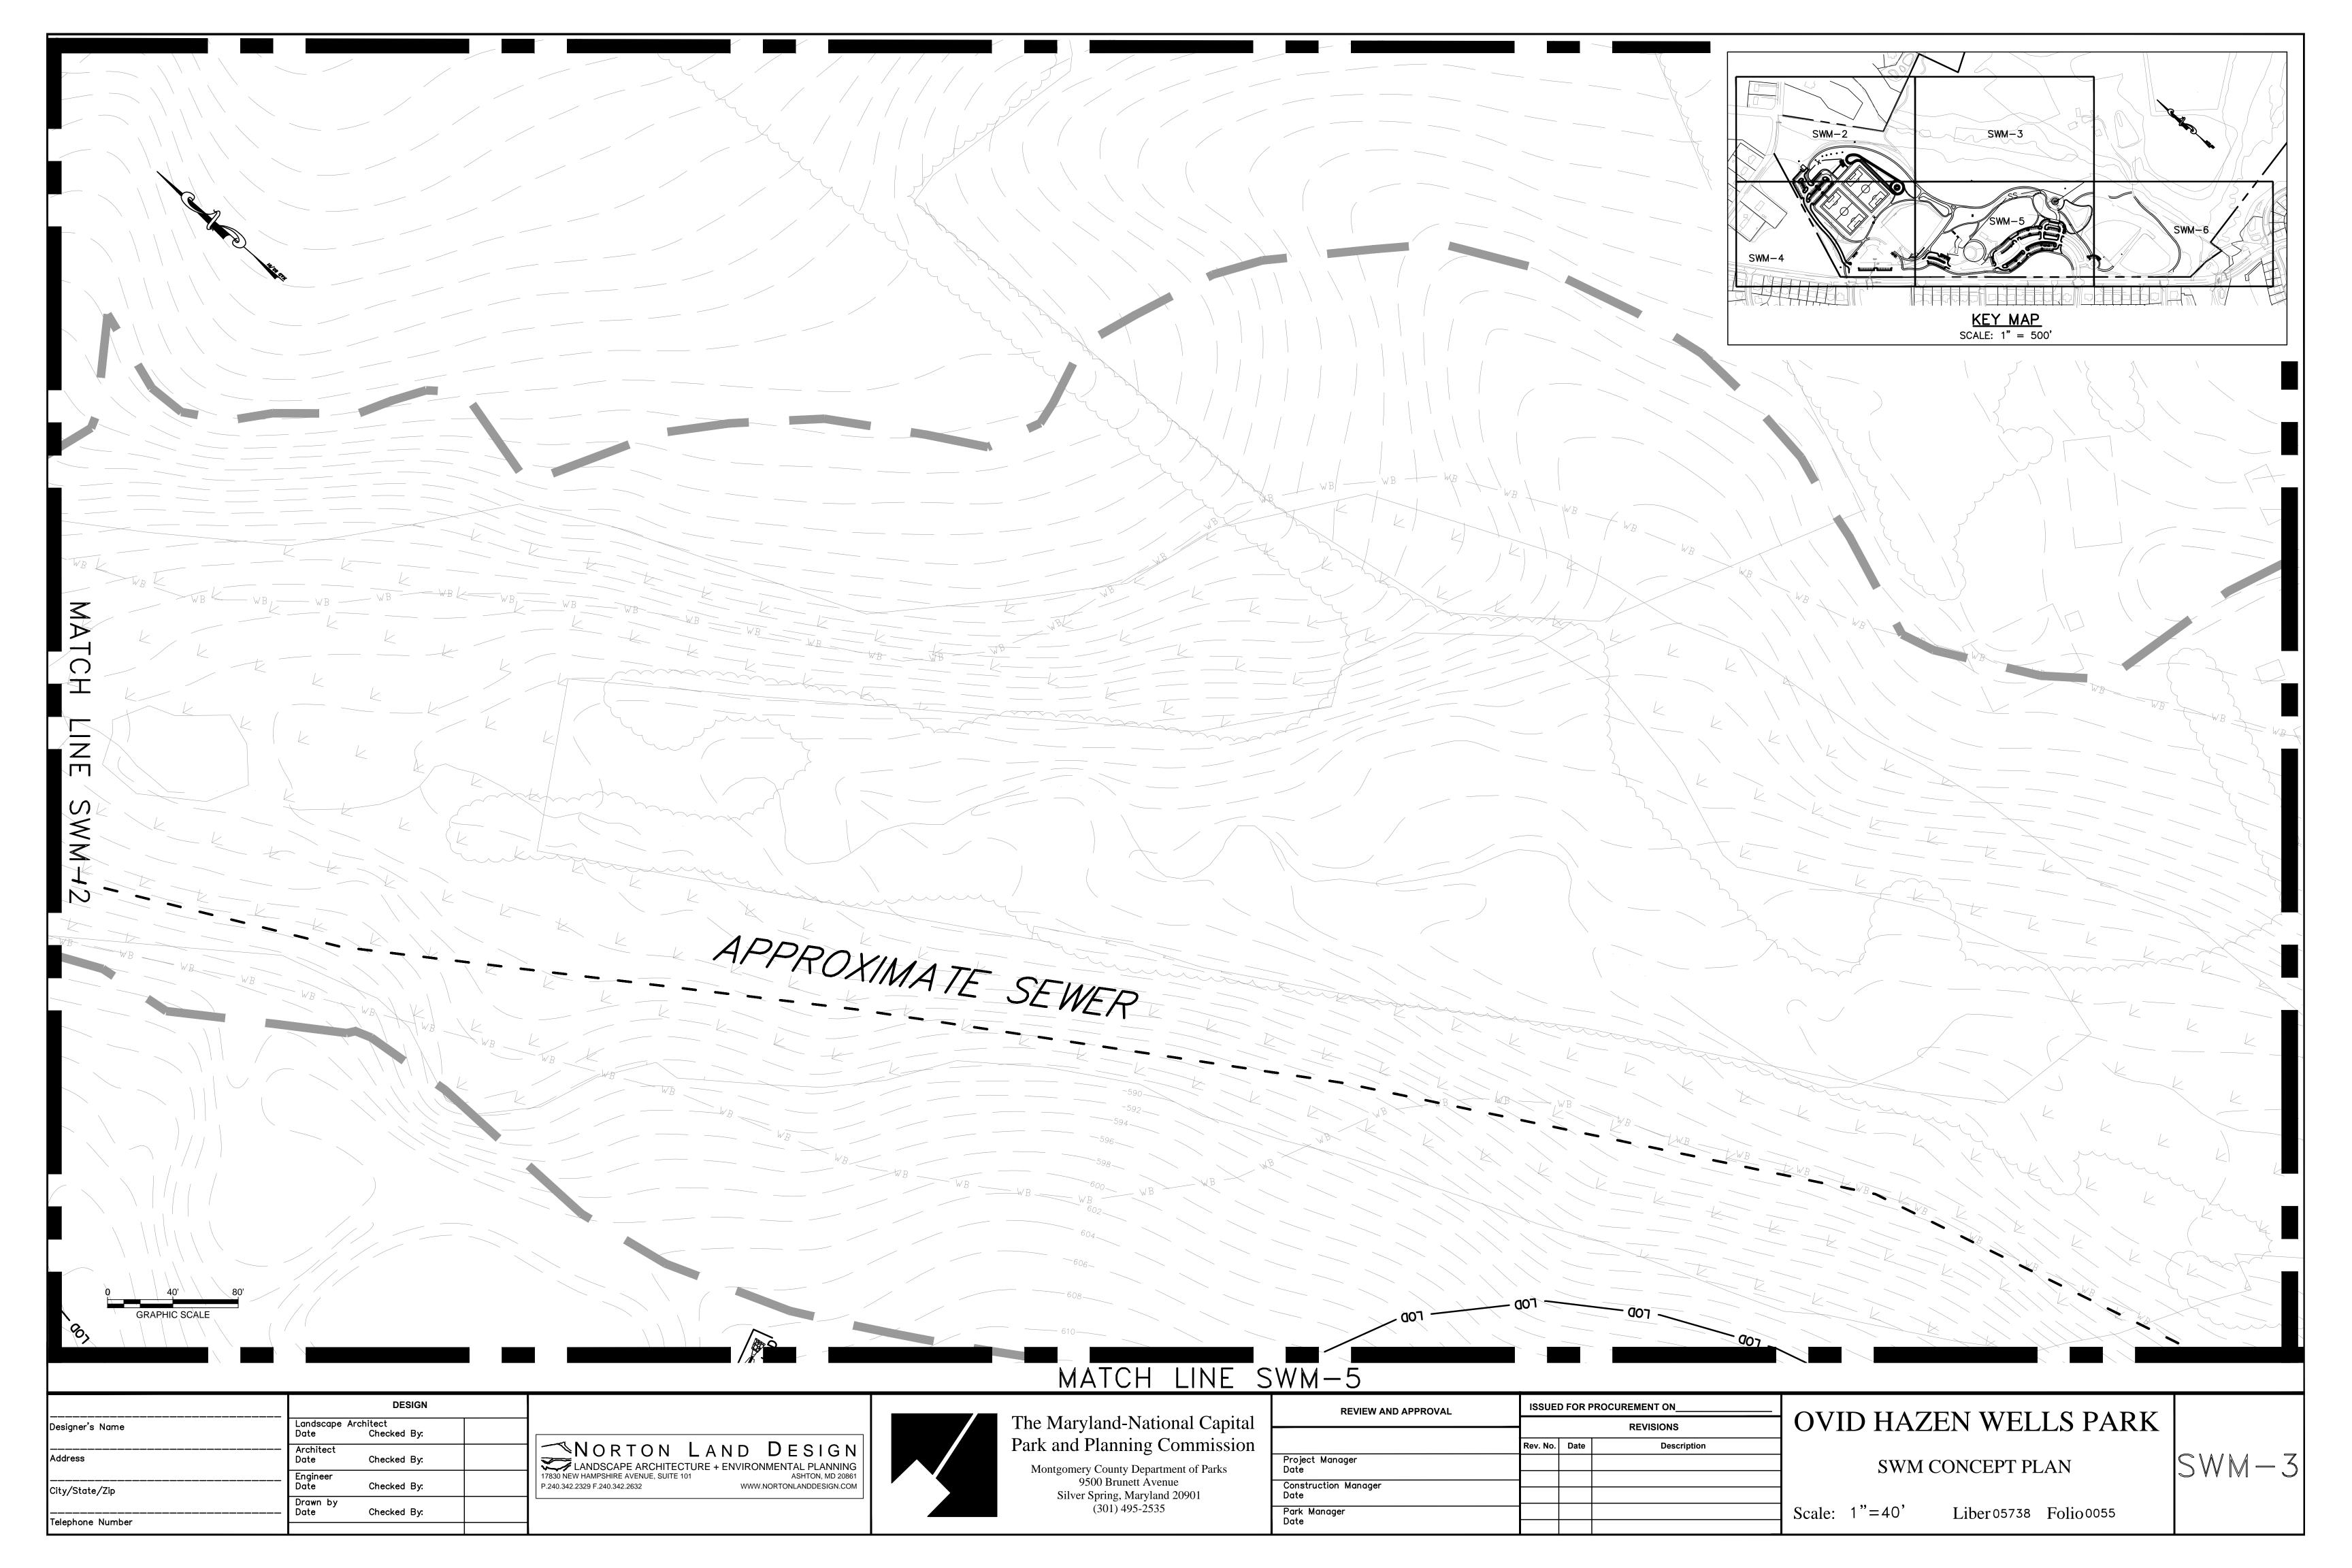


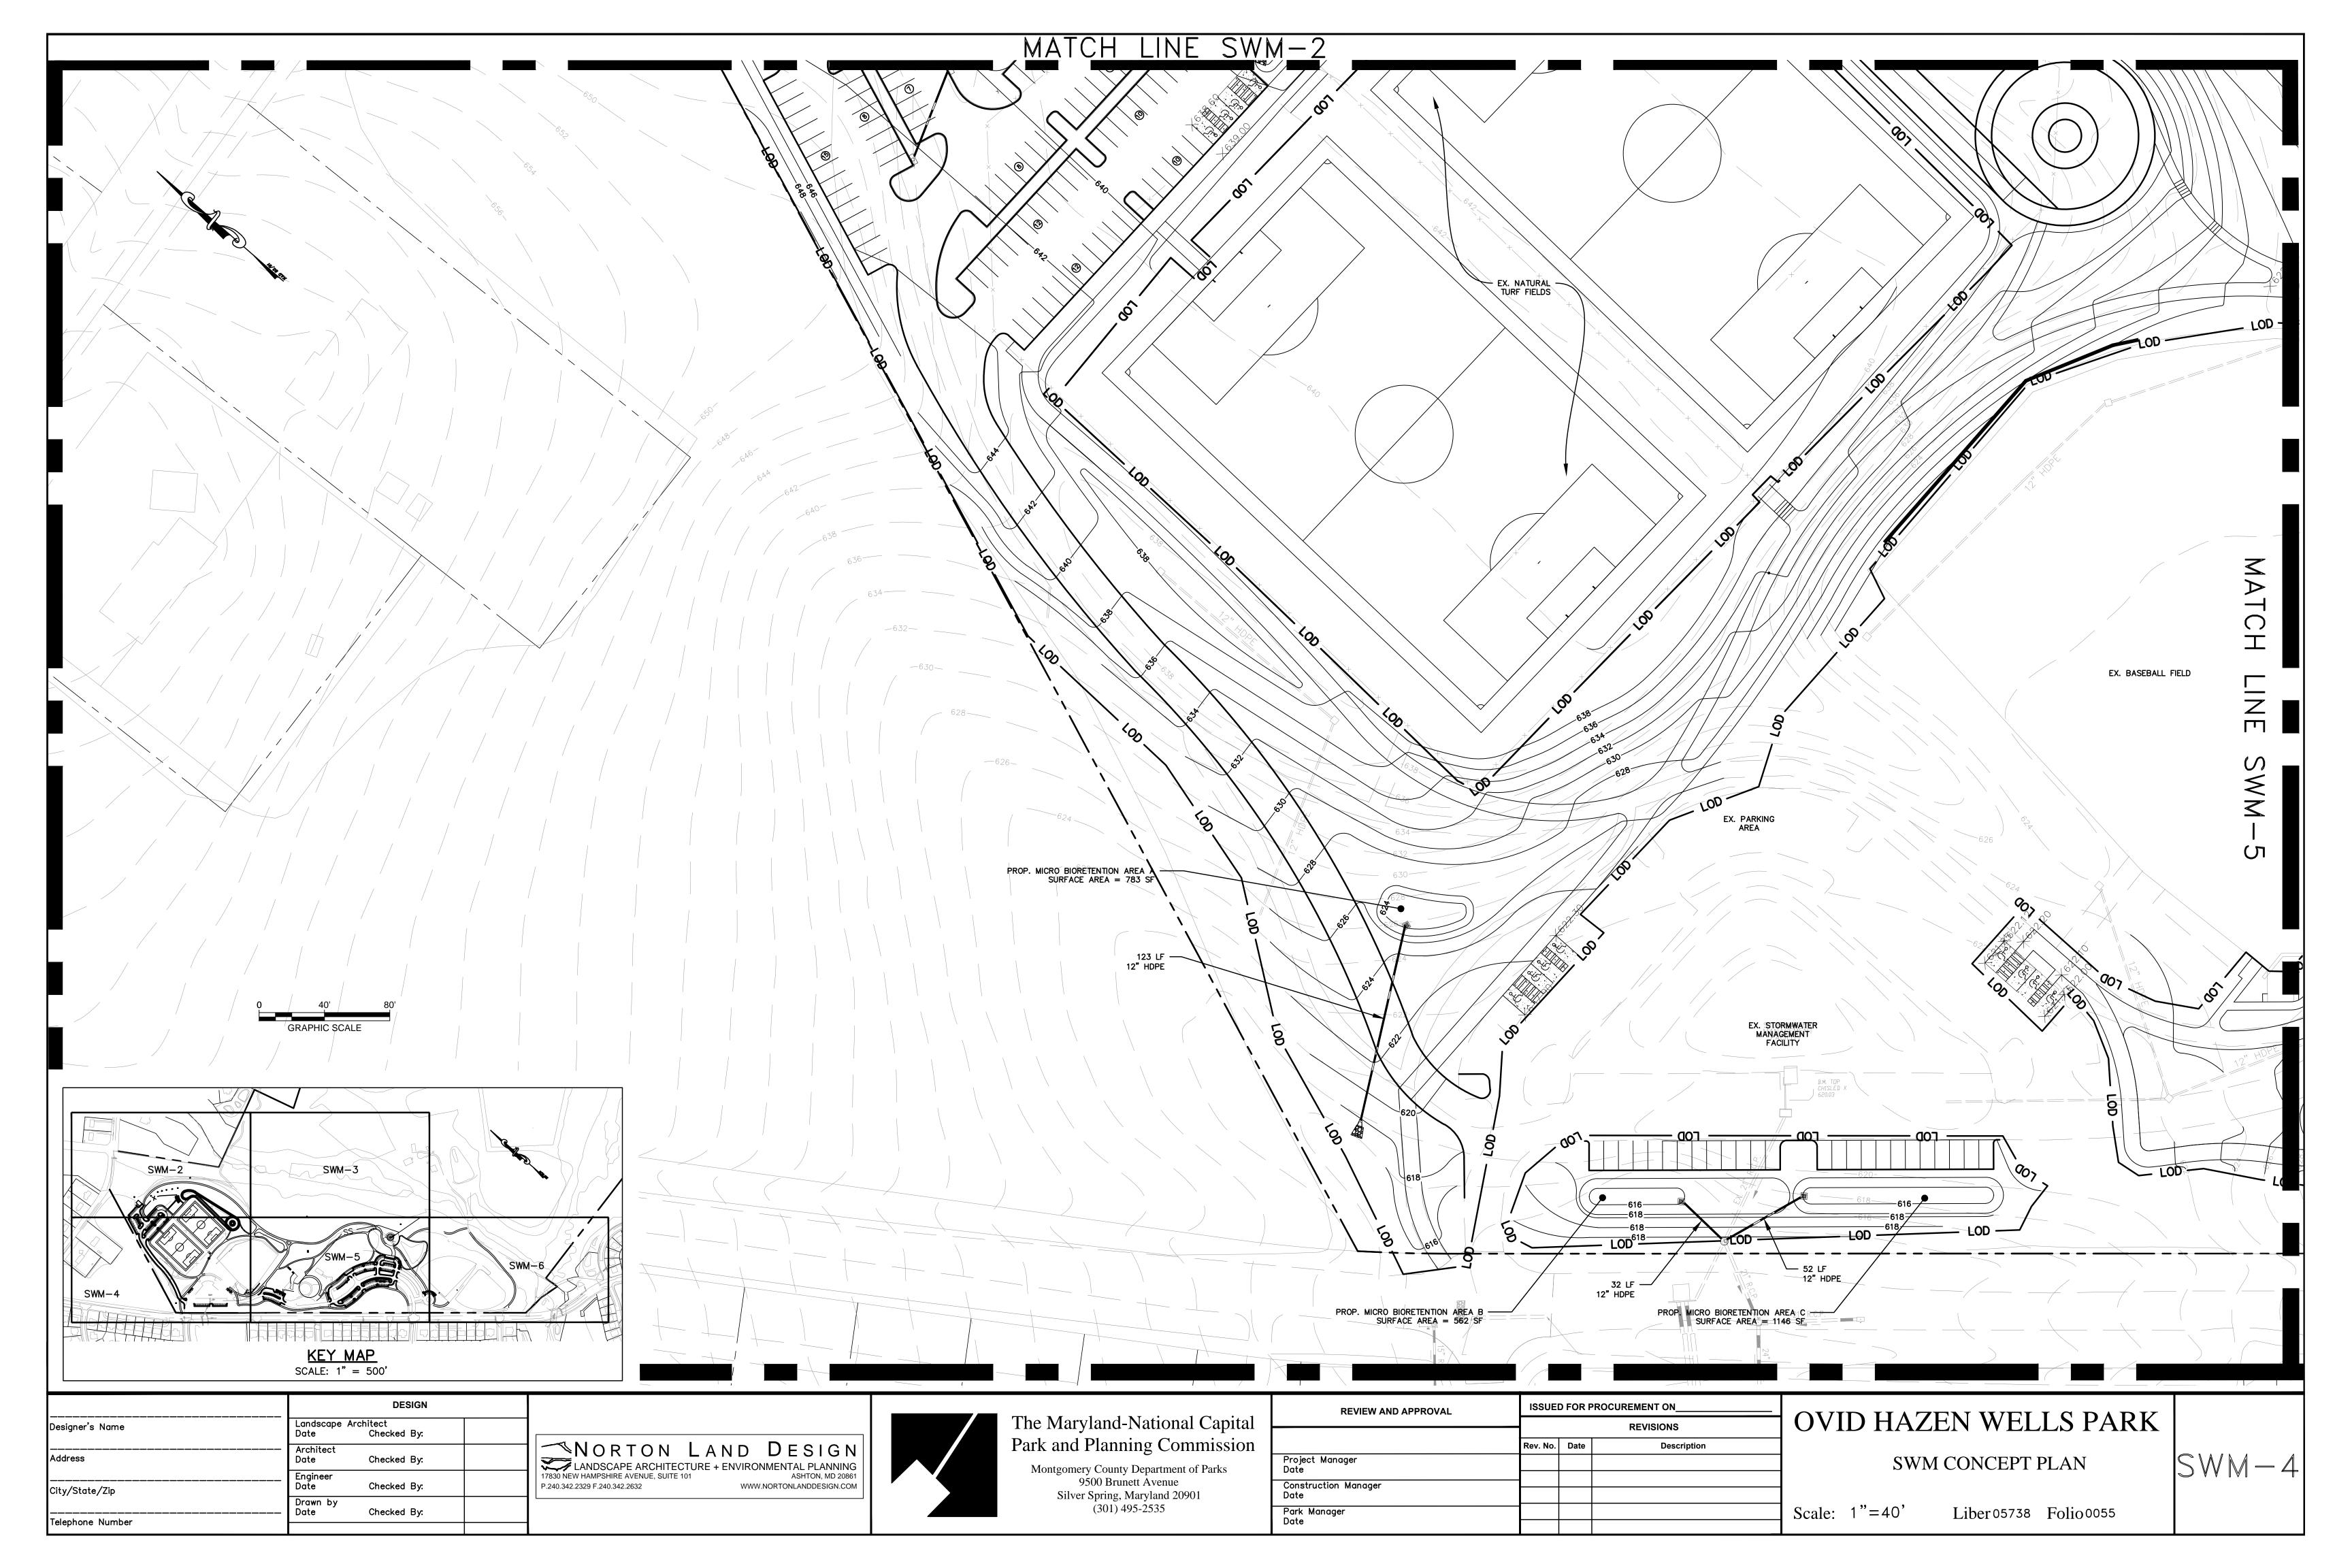

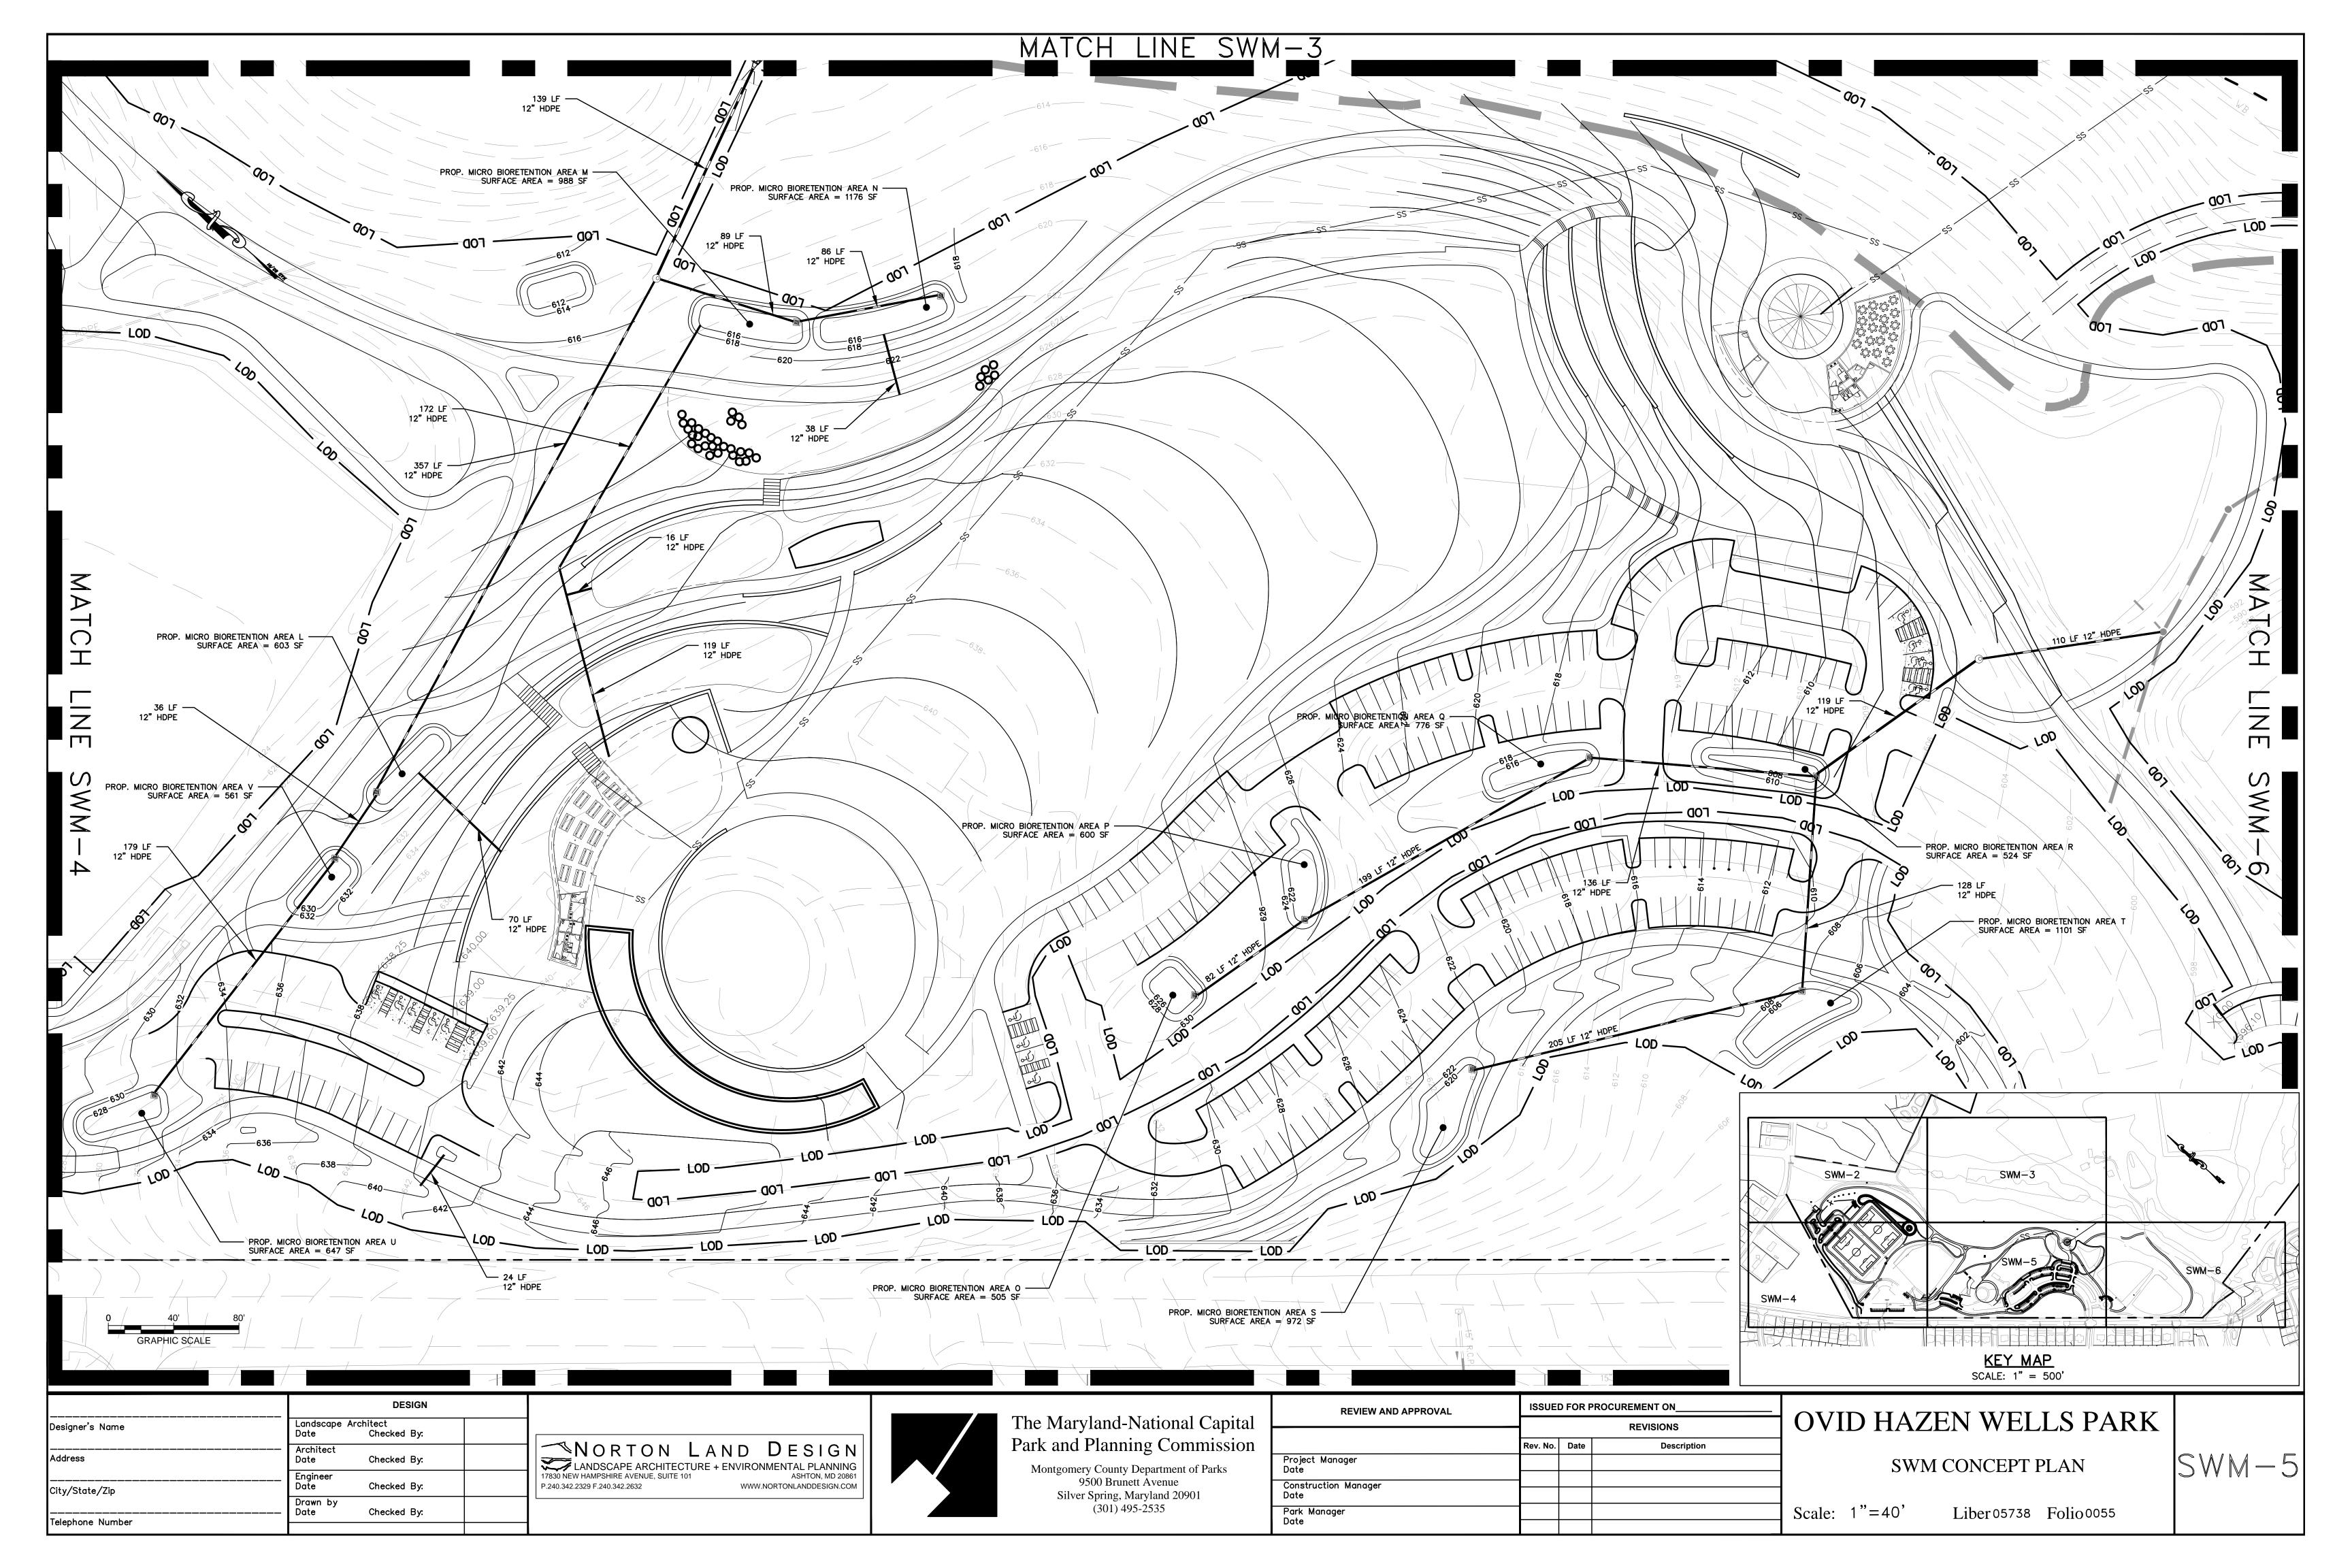

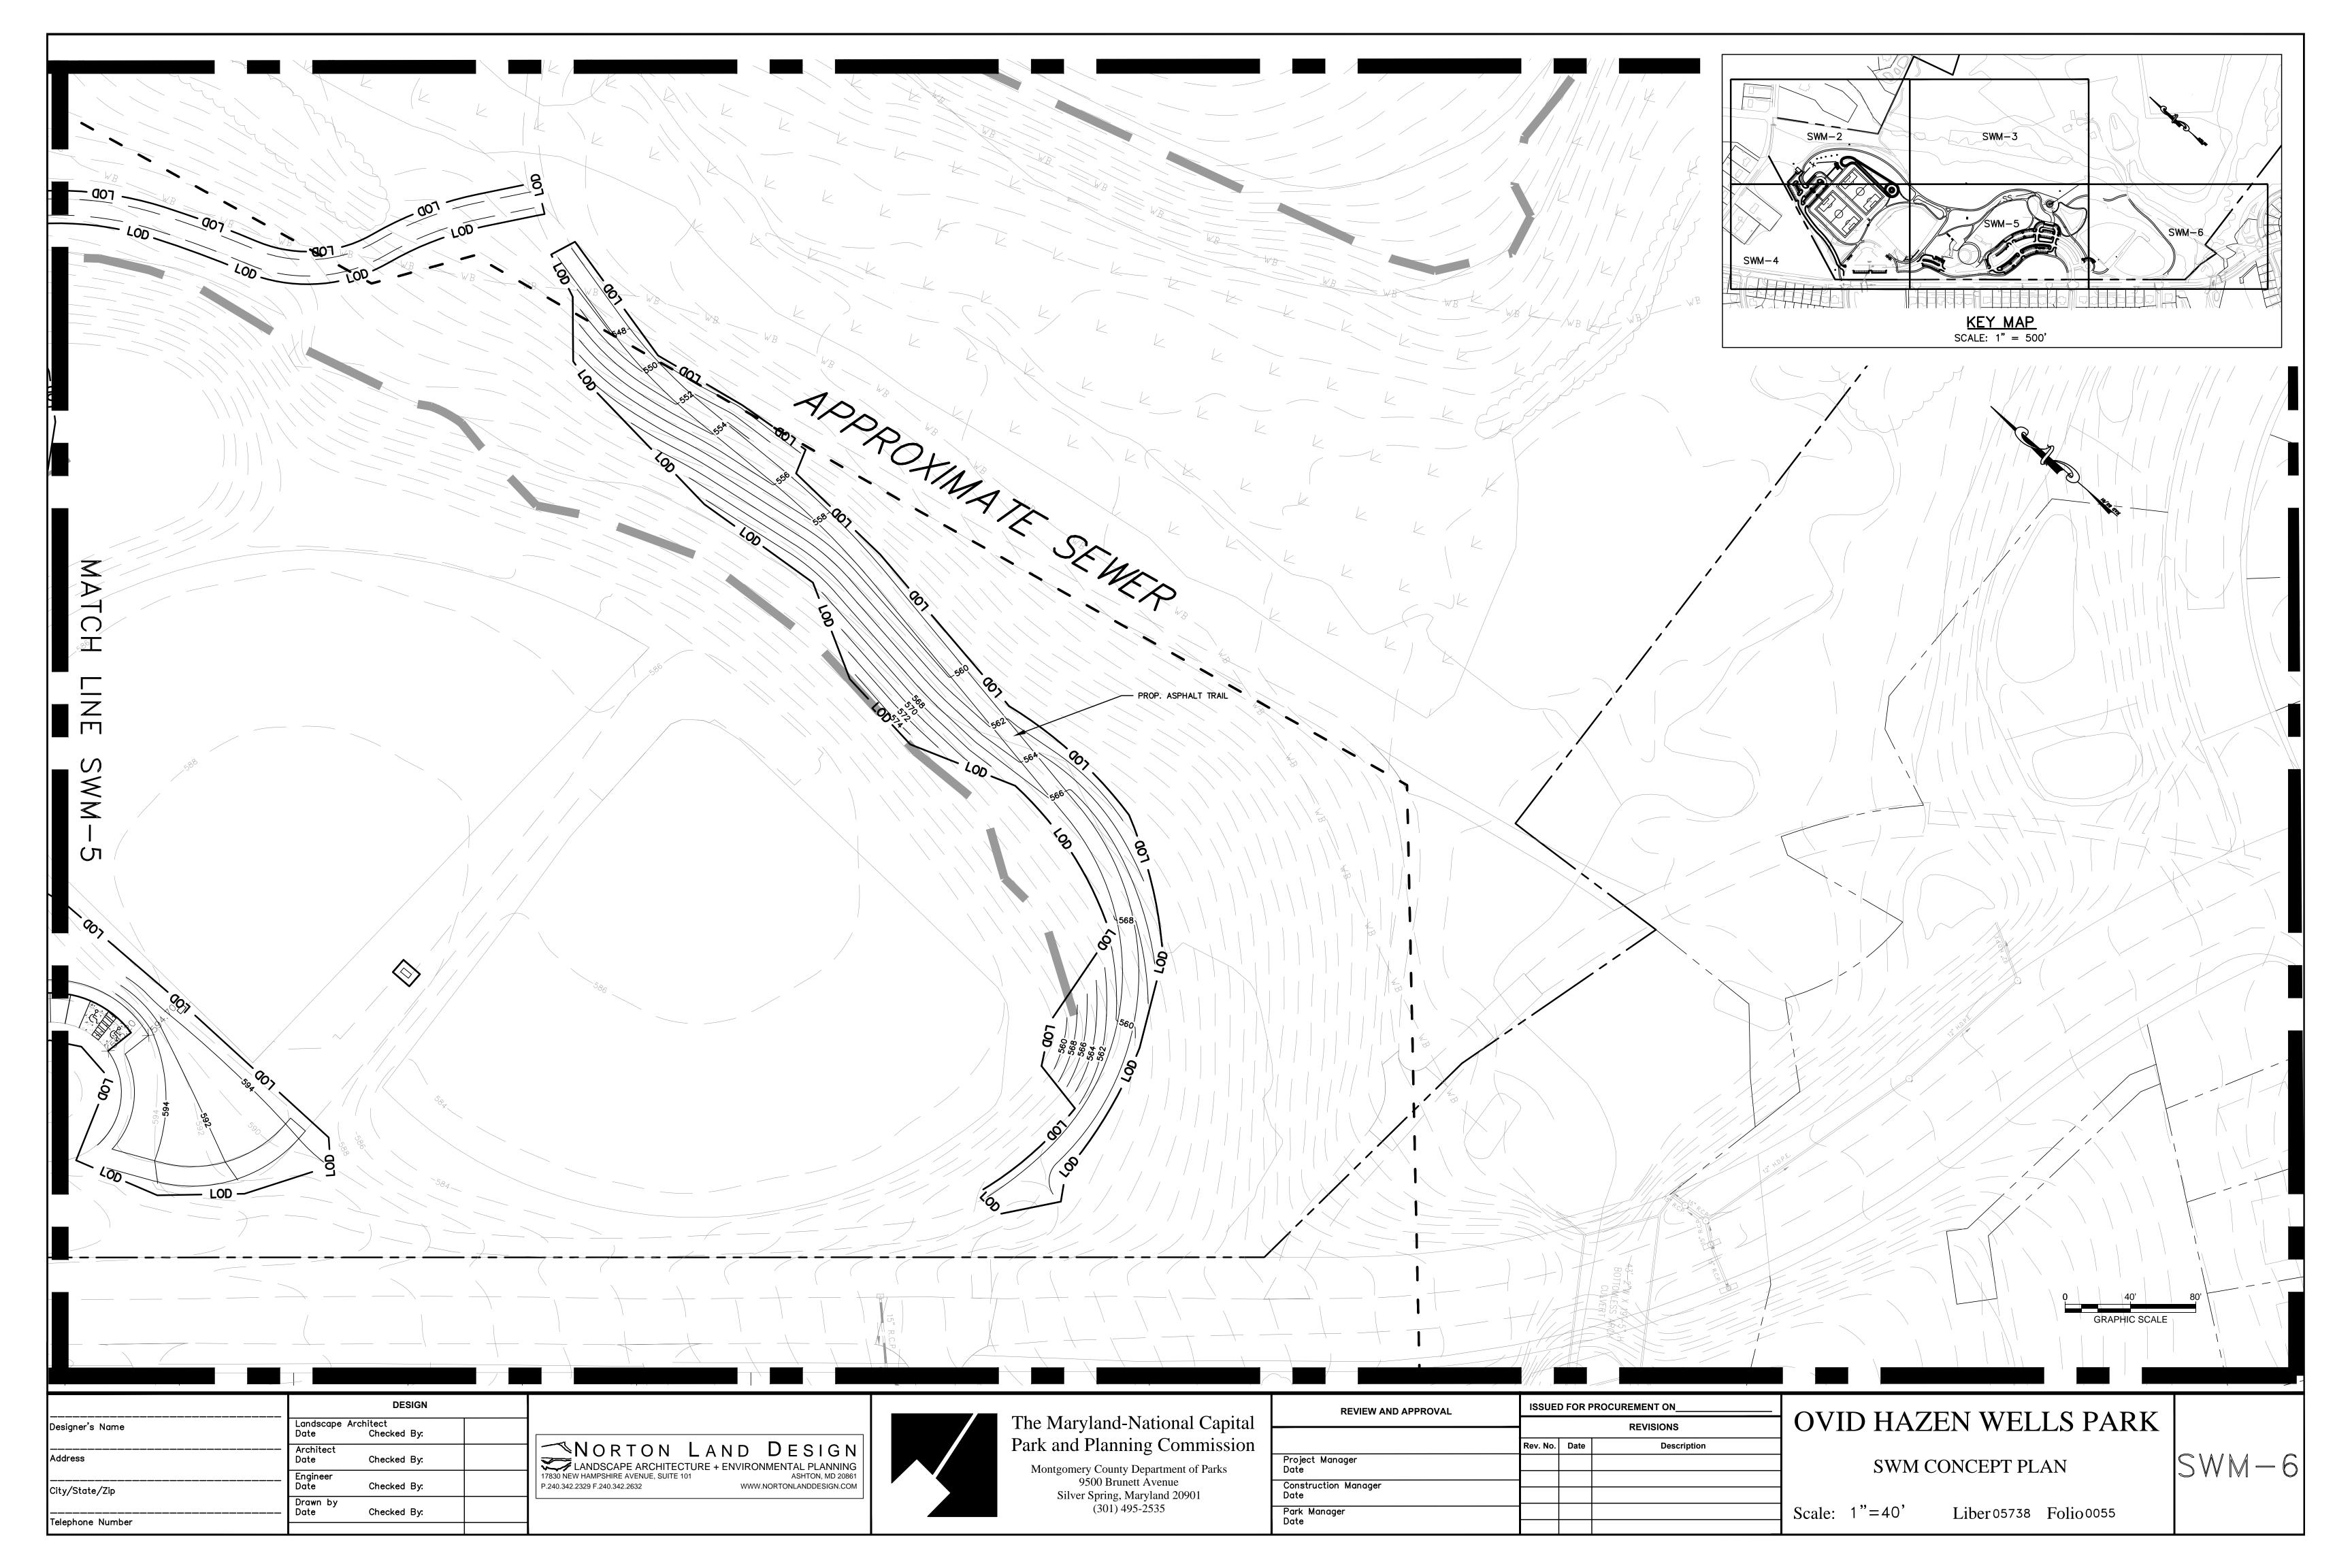

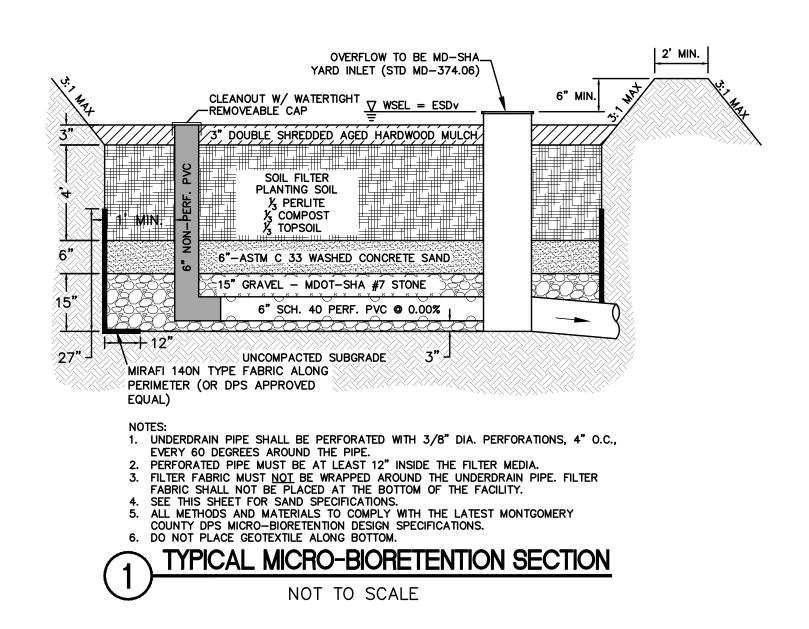

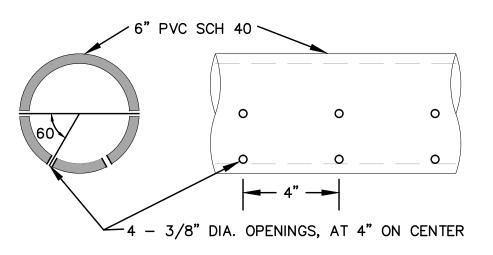



SAND SPECIFICATIONS:


WASHED ASTM C33 FINE AGGREGATE CONCRETE SAND IS UTILIZED FOR STORMWATER MANAGEMENT APPLICATIONS IN THE CITY OF ROCKVILLE. IN ADDITION TO THE ASTM C33 SPECIFICATION, SAND MUST MEET ALL OF THE FOLLOWING CONDITIONS:

SAND MUST MEET GRADATION REQUIREMENTS FOR ASTM C-33 FINE AGGREGATE CONCRETE SAND. AASHTO M-6 GRADATION IS ALSO ACCEPTABLE.
 SAND MUST BE SILICA BASED NO LIMESTONE BASED PRODUCTS MAY BE USED. IF THE MATERIAL IS WHITE OR

3. SAND MUST BE CLEAN. NATURAL, UNWASHED SAND DEPOSITS MAY NOT BE USED. LIKEWISE, SAND THAT HAS BECOME CONTAMINATED BY IMPROPER STORAGE OR INSTALLATION PRACTICES WILL BE REJECTED.

4. MANUFACTURED SAND OR STONE DUST IS NOT ACCEPTABLE UNDER ANY CIRCUMSTANCE.

GRAY IN COLOR, IT IS PROBABLY NOT ACCEPTABLE.

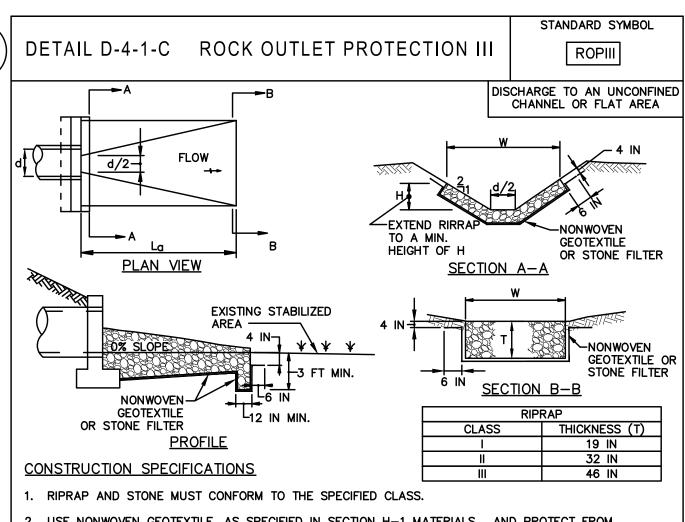



- 2. USE NONWOVEN GEOTEXTILE, AS SPECIFIED IN SECTION H-1 MATERIALS, AND PROTECT FROM PUNCTURING, CUTTING, OR TEARING. REPAIR ANY DAMAGE OTHER THAN AN OCCASIONAL SMALL HOLE BY PLACING ANOTHER PIECE OF GEOTEXTILE OVER THE DAMAGED PART OR BY COMPLETELY REPLACING THE GEOTEXTILE. PROVIDE A MINIMUM OF ONE FOOT OVERLAP FOR ALL REPAIRS AND FOR JOINING TWO PIECES OF GEOTEXTILE TOGETHER.
- 3. PREPARE THE SUBGRADE FOR GEOTEXTILE OR STONE FILTER (% TO 1½ INCH MINIMUM STONE FOR 6 INCH MINIMUM DEPTH) AND RIPRAP TO THE REQUIRED LINES AND GRADES. COMPACT ANY FILL REQUIRED IN THE SUBGRADE TO A DENSITY OF APPROXIMATELY THAT OF THE SURROUNDING UNDISTURBED MATERIAL.
- 4. EXTEND GEOTEXTILE AT LEAST 6 INCHES BEYOND EDGES OF RIPRAP AND EMBED AT LEAST 4 INCHES AT SIDES OF RIPRAP.
- 5. CONSTRUCT RIPRAP OUTLET TO FULL COURSE THICKNESS IN ONE OPERATION AND IN SUCH A MANNER AS TO AVOID DISPLACEMENT OF UNDERLYING MATERIALS. PLACE STONE FOR RIPRAP OUTLET IN A MANNER THAT WILL ENSURE THAT IT IS REASONABLY HOMOGENOUS WITH THE SMALLER STONES AND SPALLS FILLING THE VOIDS BETWEEN THE LARGER STONES. PLACE RIPRAP IN A MANNER TO PREVENT DAMAGE TO THE FILTER BLANKET OR GEOTEXTILE. HAND PLACE TO THE EXTENT NECESSARY.
- WHERE NO ENDWALL IS USED, CONSTRUCT THE UPSTREAM END OF THE APRON SO THAT THE WIDTH IS TWO TIMES THE DIAMETER OF THE OUTLET PIPE, AND EXTEND THE STONE UNDER THE OUTLET BY A MINIMUM OF 18 INCHES
- 7. CONSTRUCT APRON WITH 0% SLOPE ALONG ITS LENGTH AND WITHOUT OBSTRUCTIONS. PLACE STONE SO THAT IT BLENDS IN WITH EXISTING GROUND.
- 8. MAINTAIN LINE, GRADE, AND CROSS SECTION. KEEP OUTLET FREE OF EROSION. REMOVE ACCUMULATED SEDIMENT AND DEBRIS. AFTER HIGH FLOWS INSPECT FOR SCOUR AND RIPRAP DISLODGED RIPRAP. MAKE NECESSARY REPAIRS IMMEDIATELY.


U.S. DEPARTMENT OF AGRICULTURE
NATURAL RESOURCES CONSERVATION SERVICE


MARYLAND STANDARDS AND SPECIFICATIONS FOR SOIL EROSION AND SEDIMENT CONTROL

MARYLAND DEPARTMENT OF ENVIRONMENT
WATER MANAGEMENT ADMINISTRATION

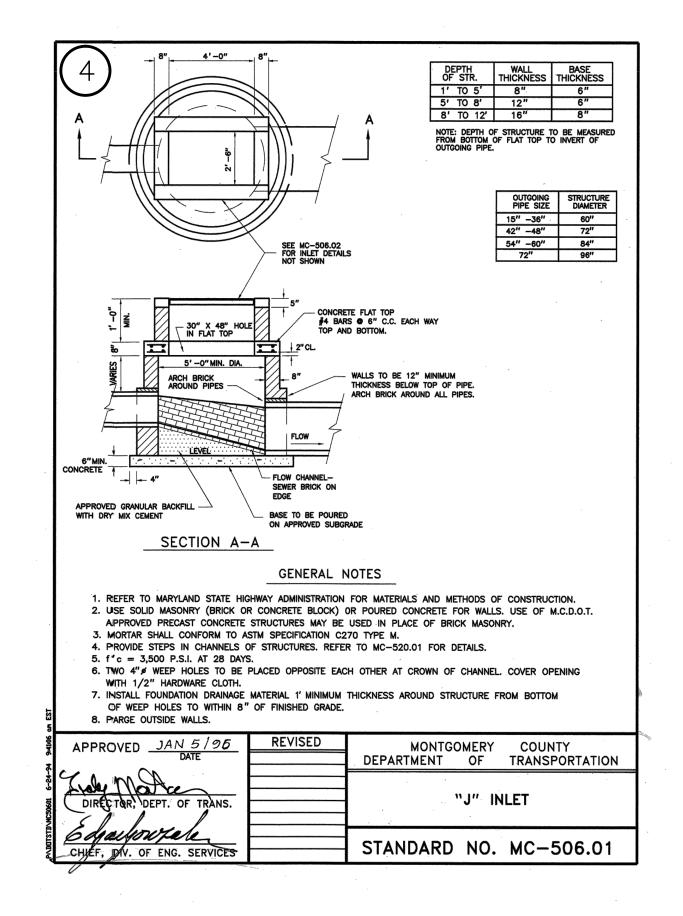

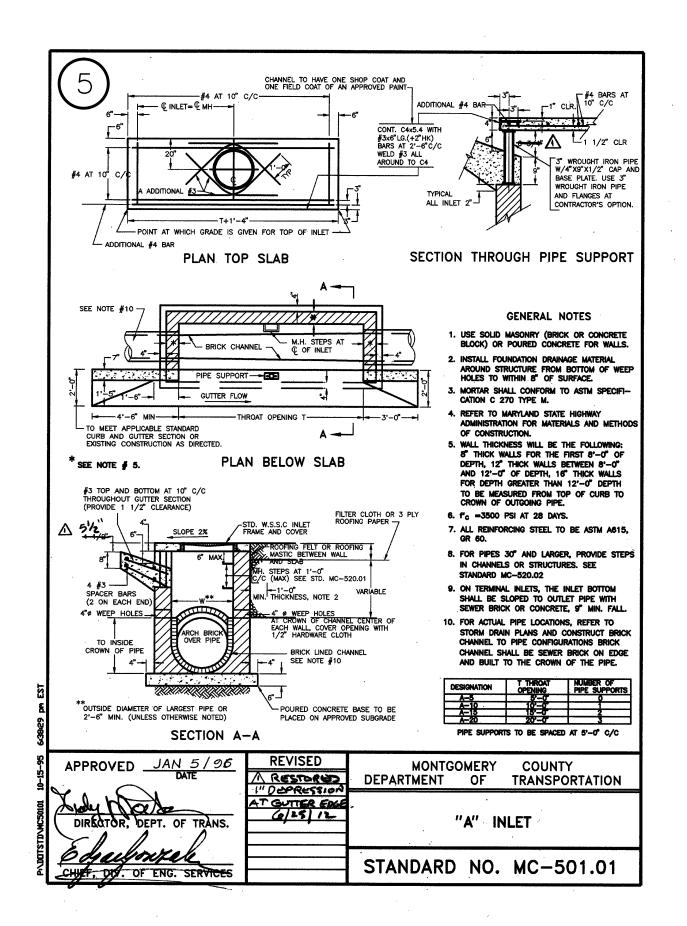

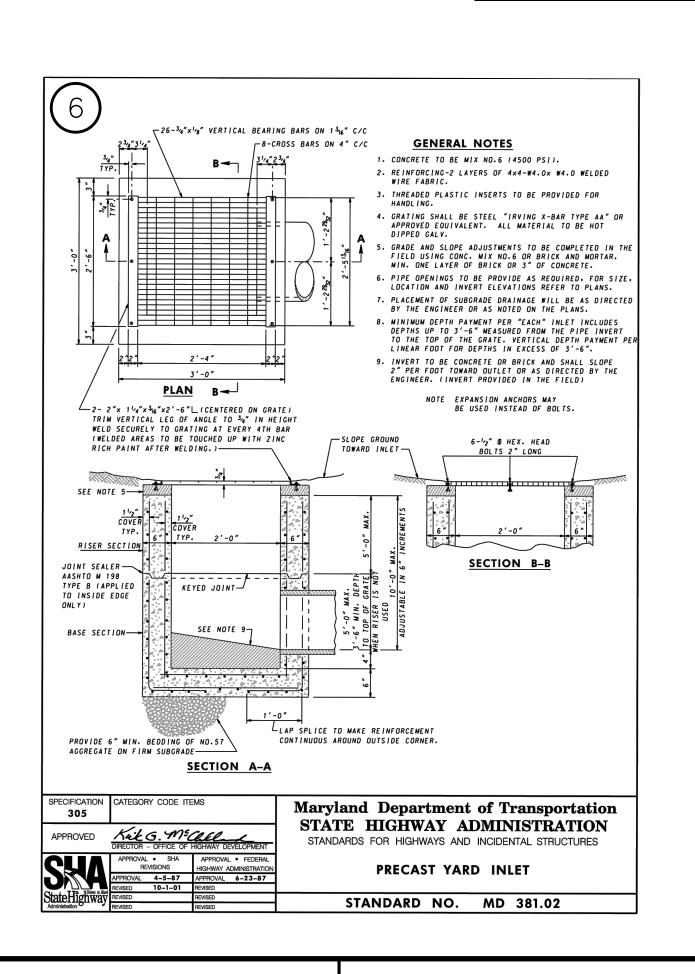

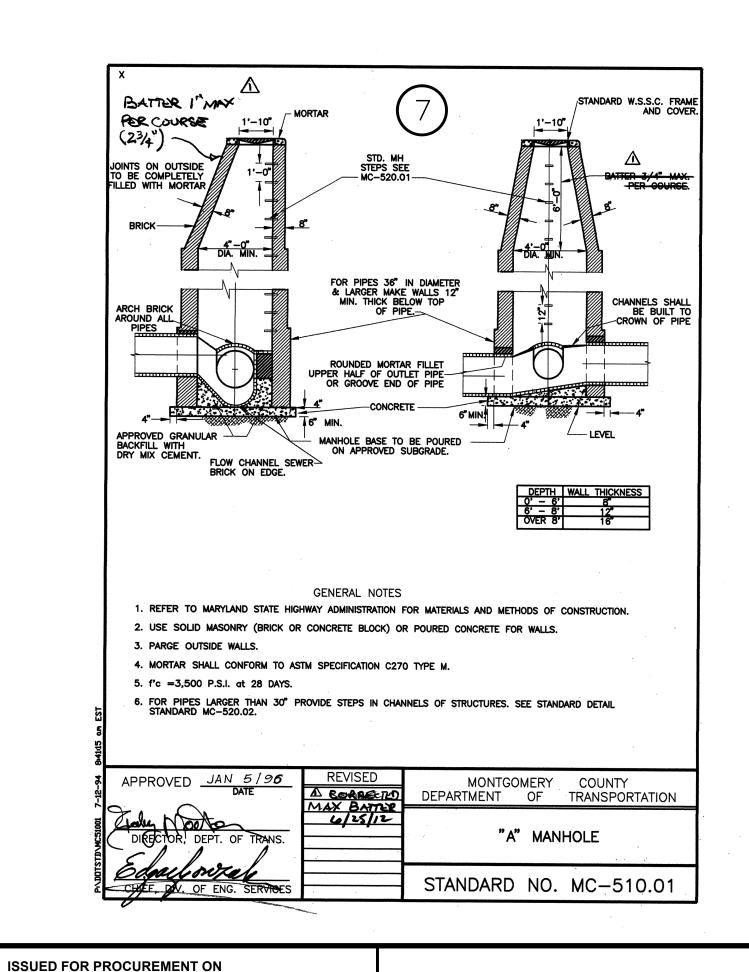

		DESIGN	
Designer's Name	Landscape A Date	rchitect Checked By:	١,
Address	Architect Date	Checked By:	
 City/State/Zip	Engineer Date	Checked By:	
Telephone Number	Drawn by Date	Checked By:	

NORTON LAND DESIGN
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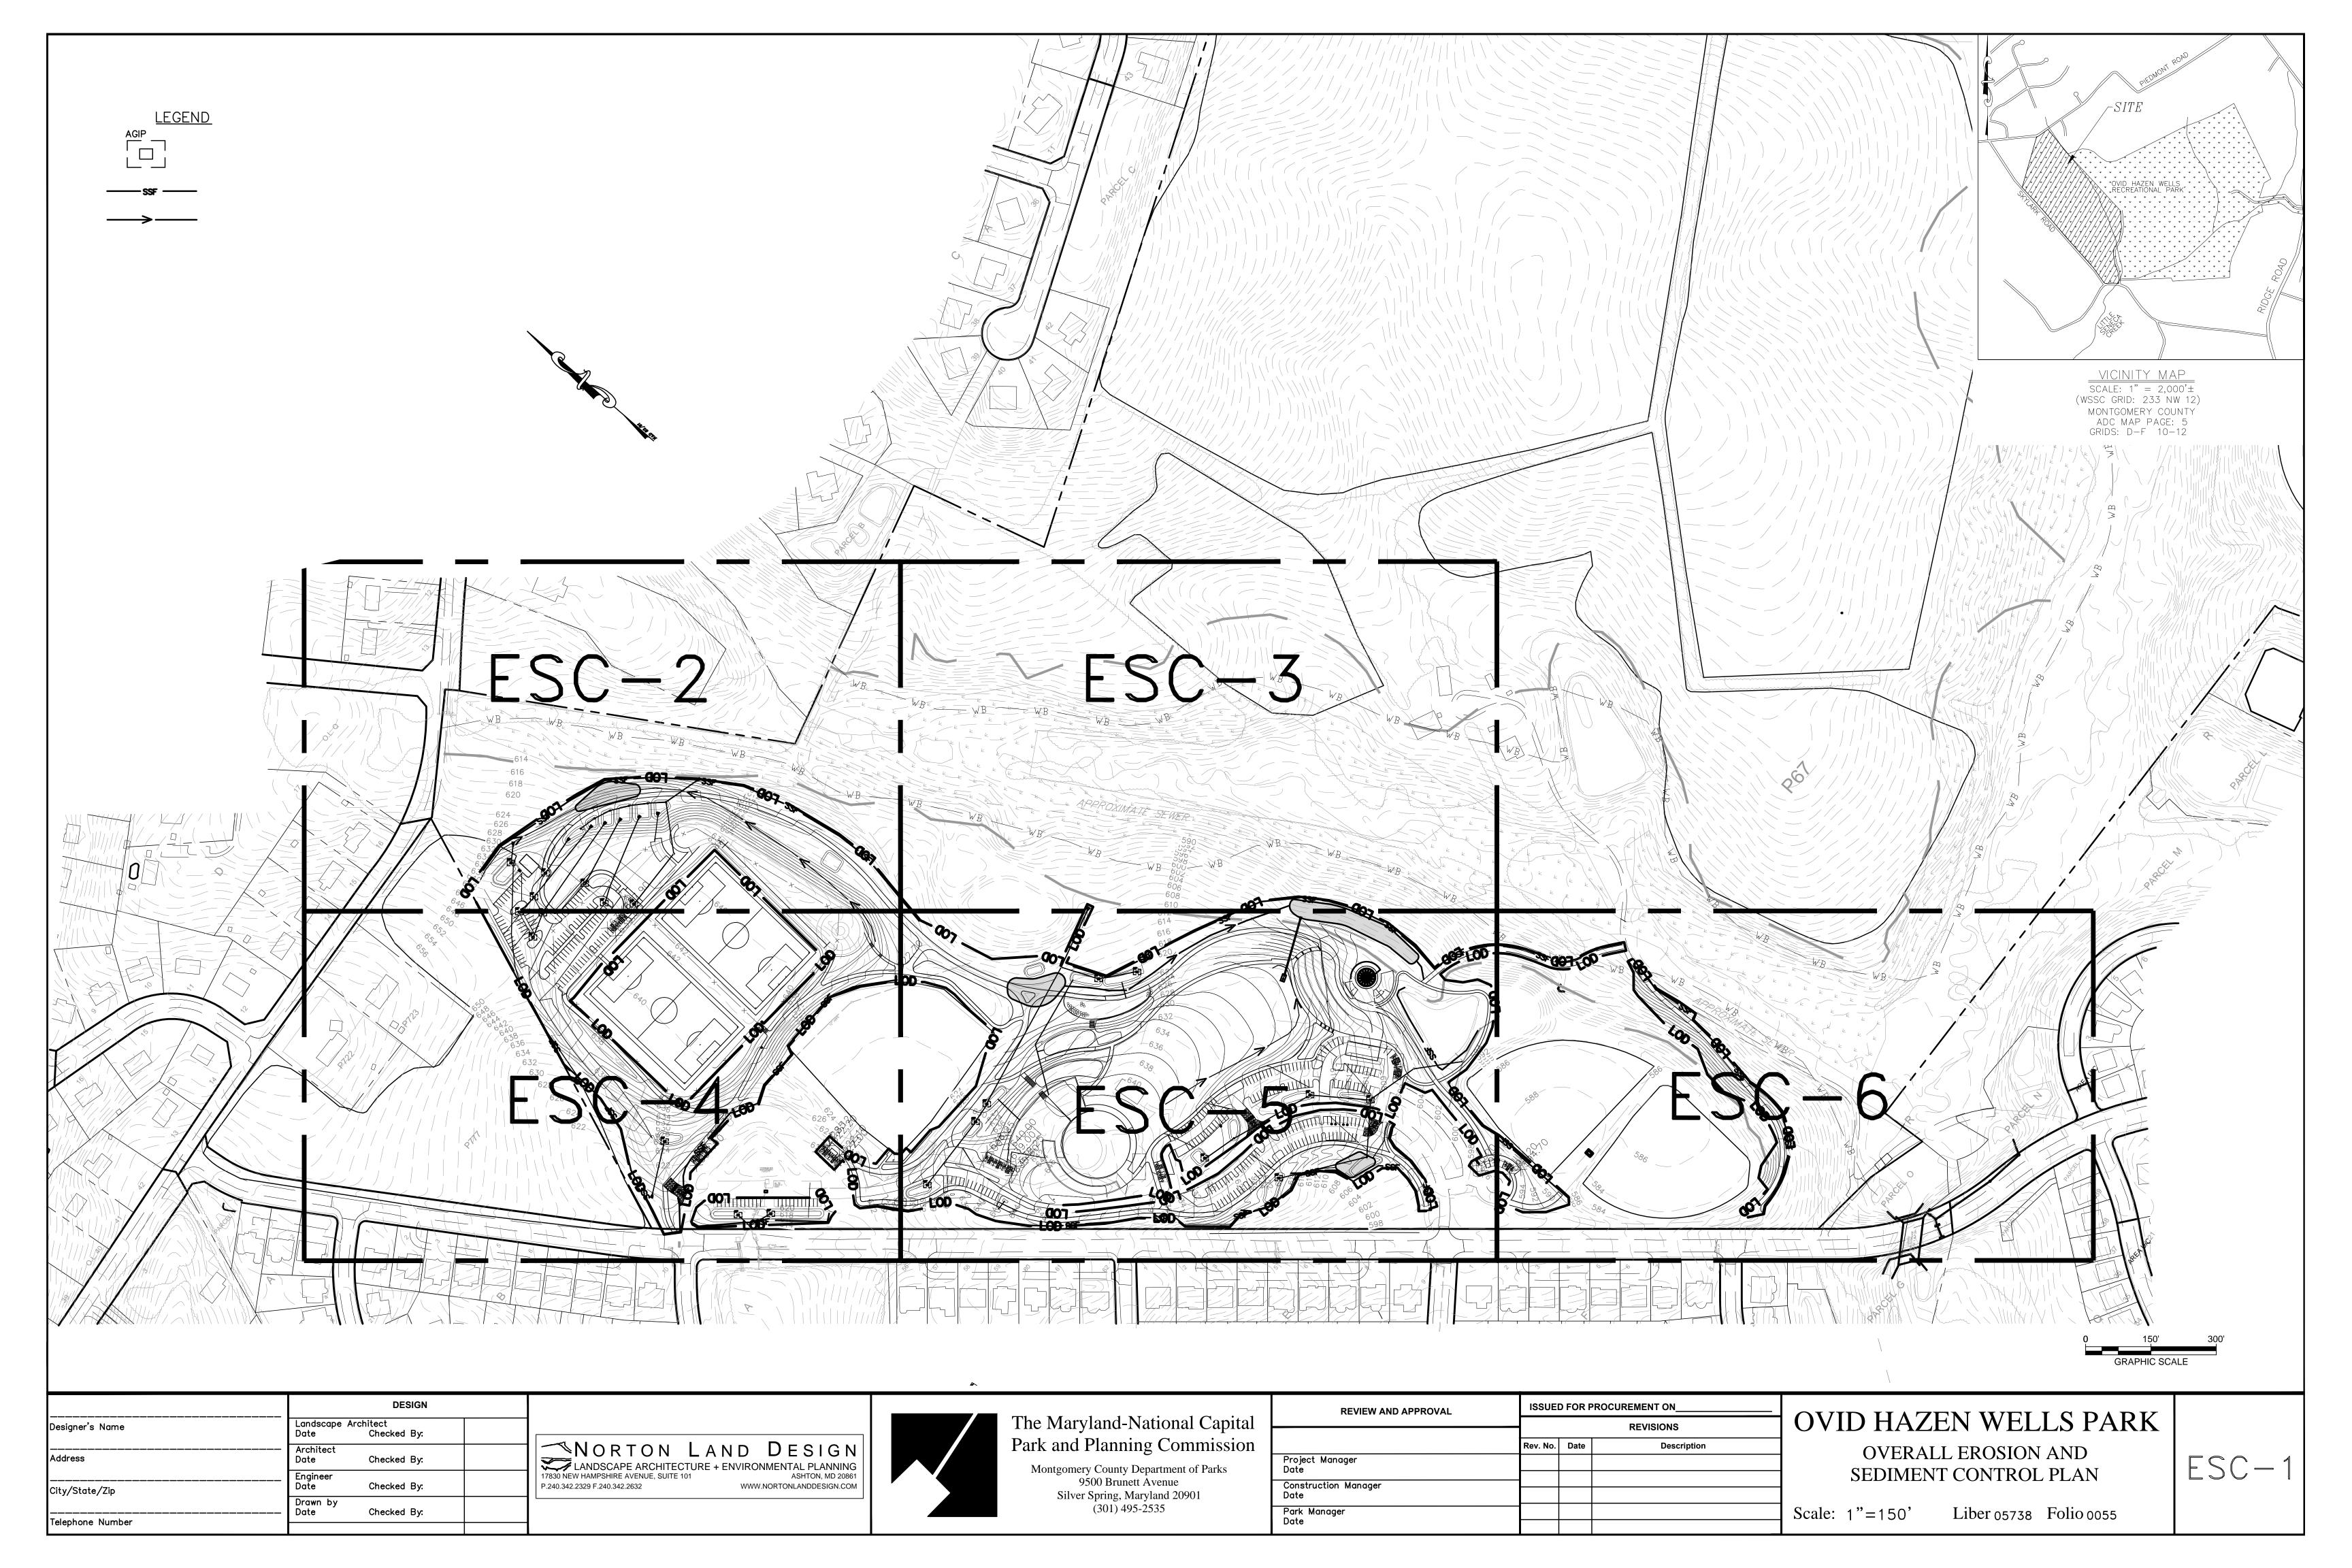
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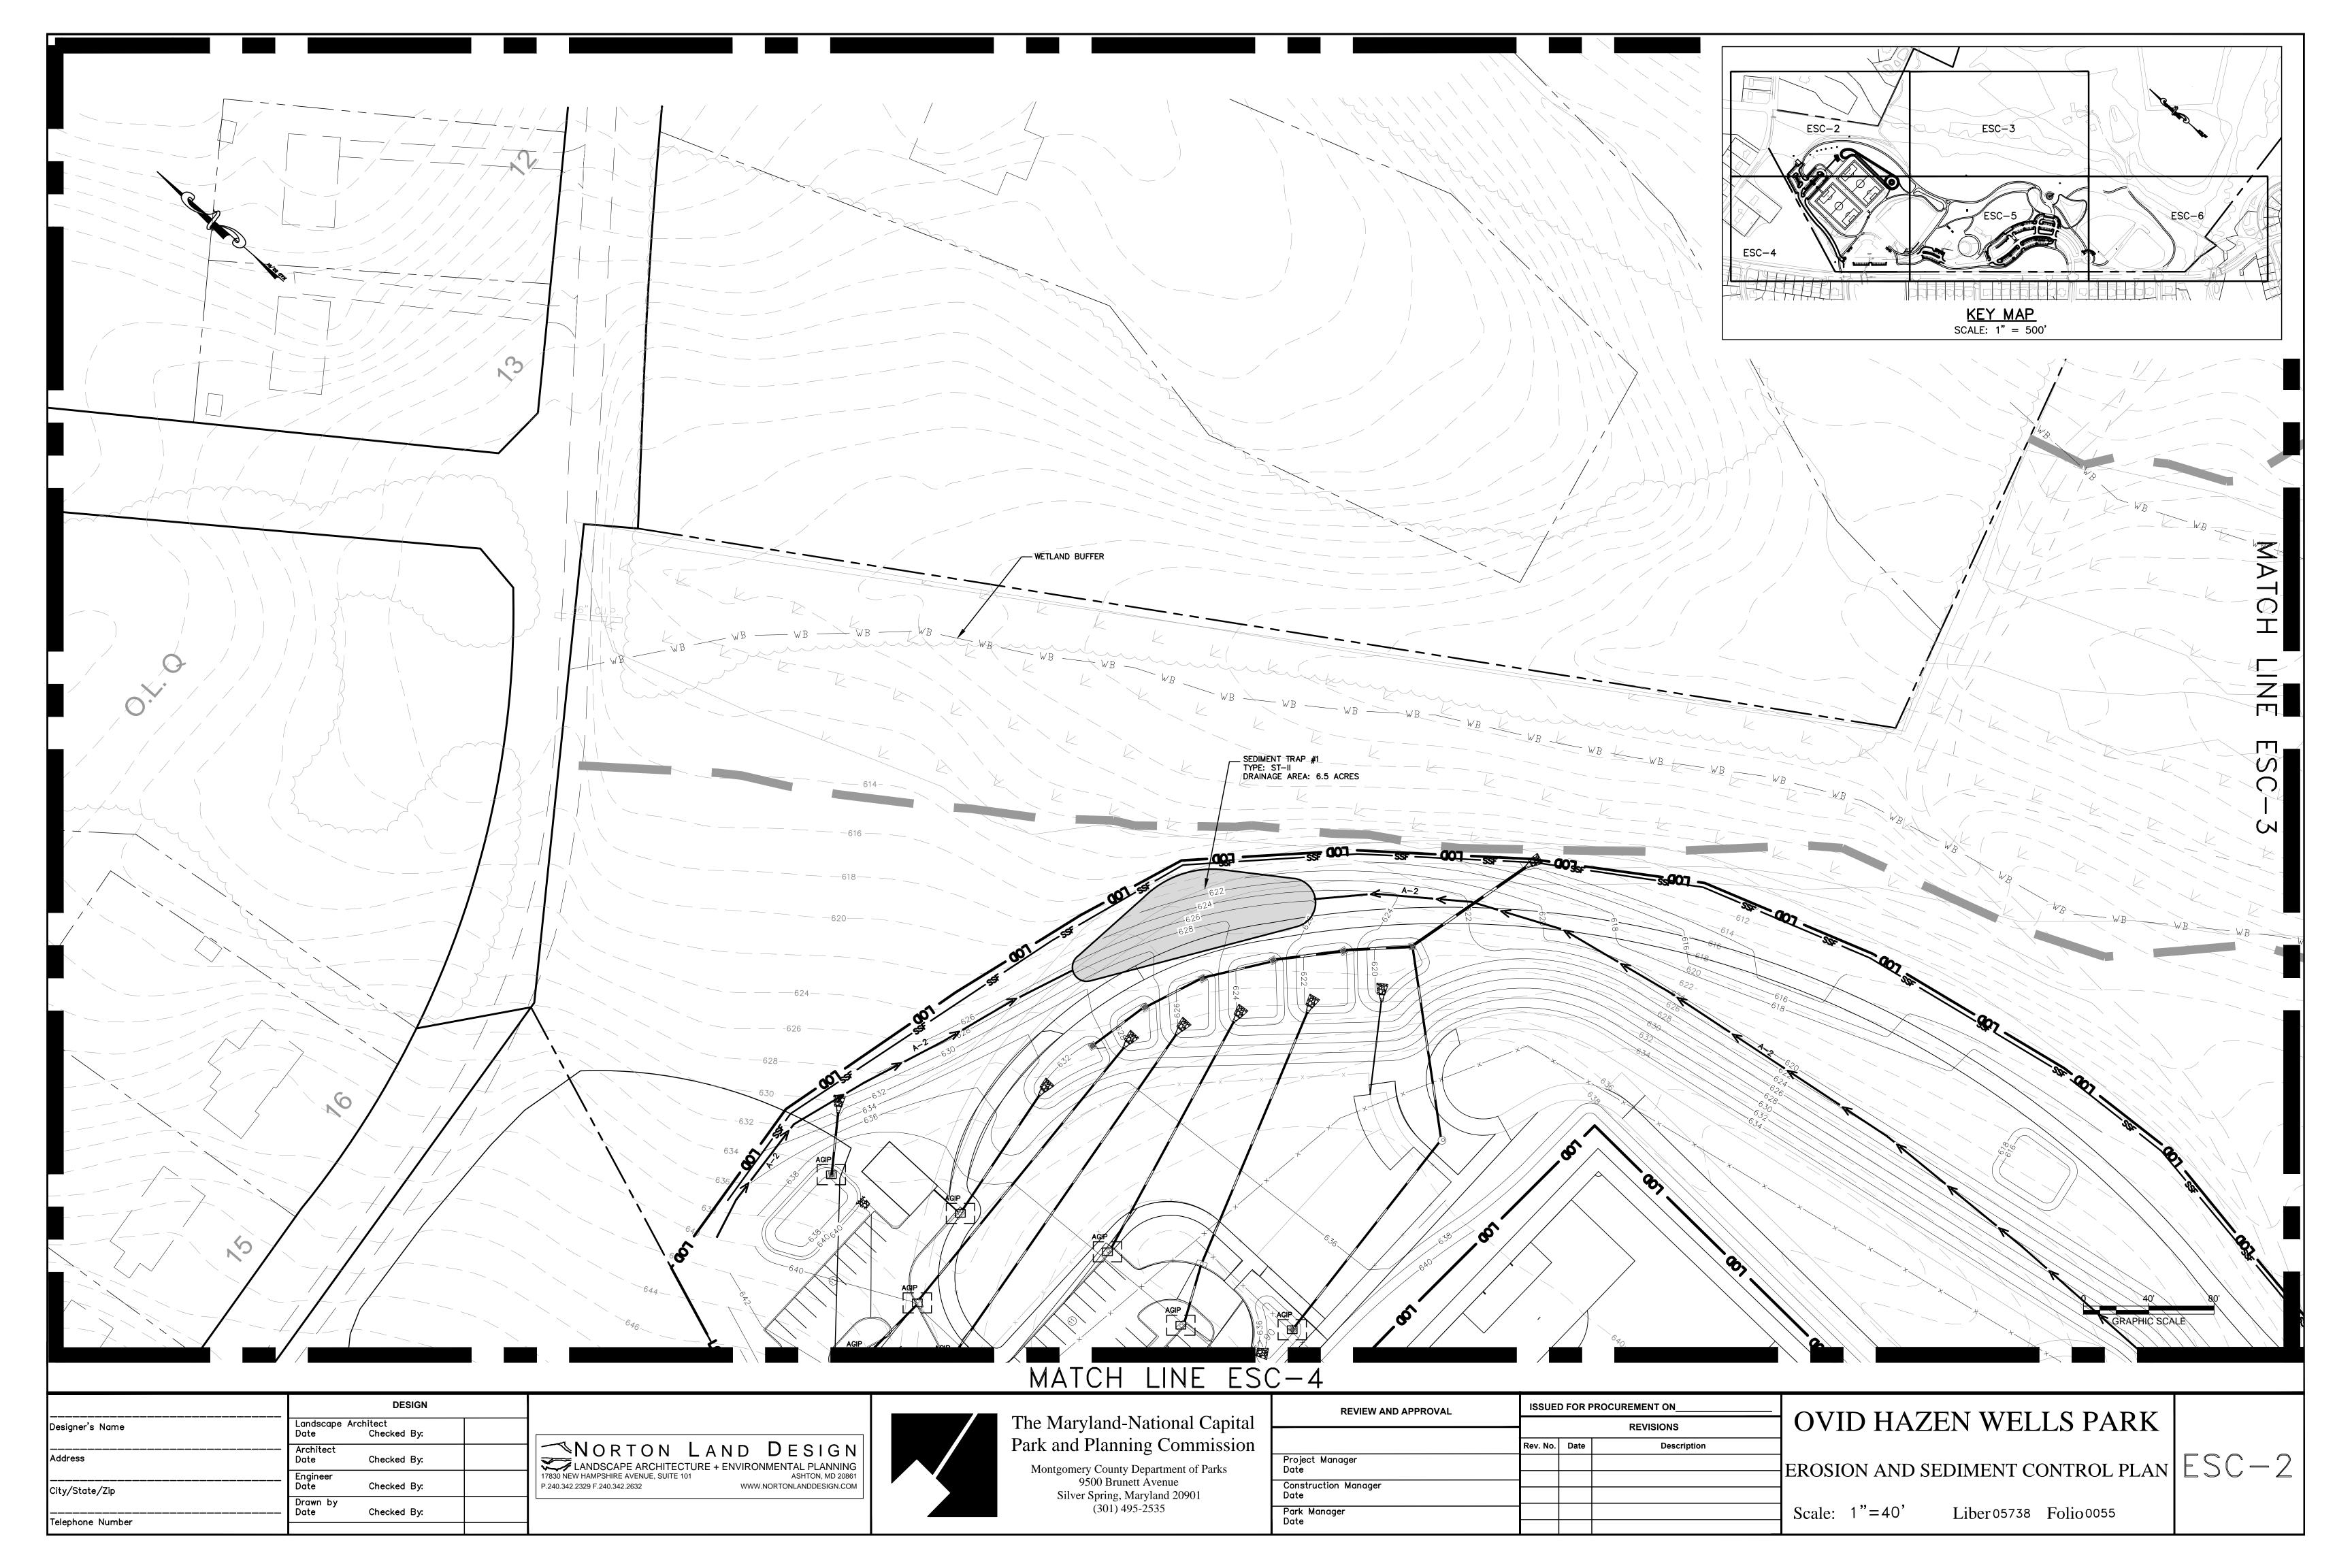
OVID HAZEN WELLS PARK


STORMWATER
MANAGEMENT DETAILS


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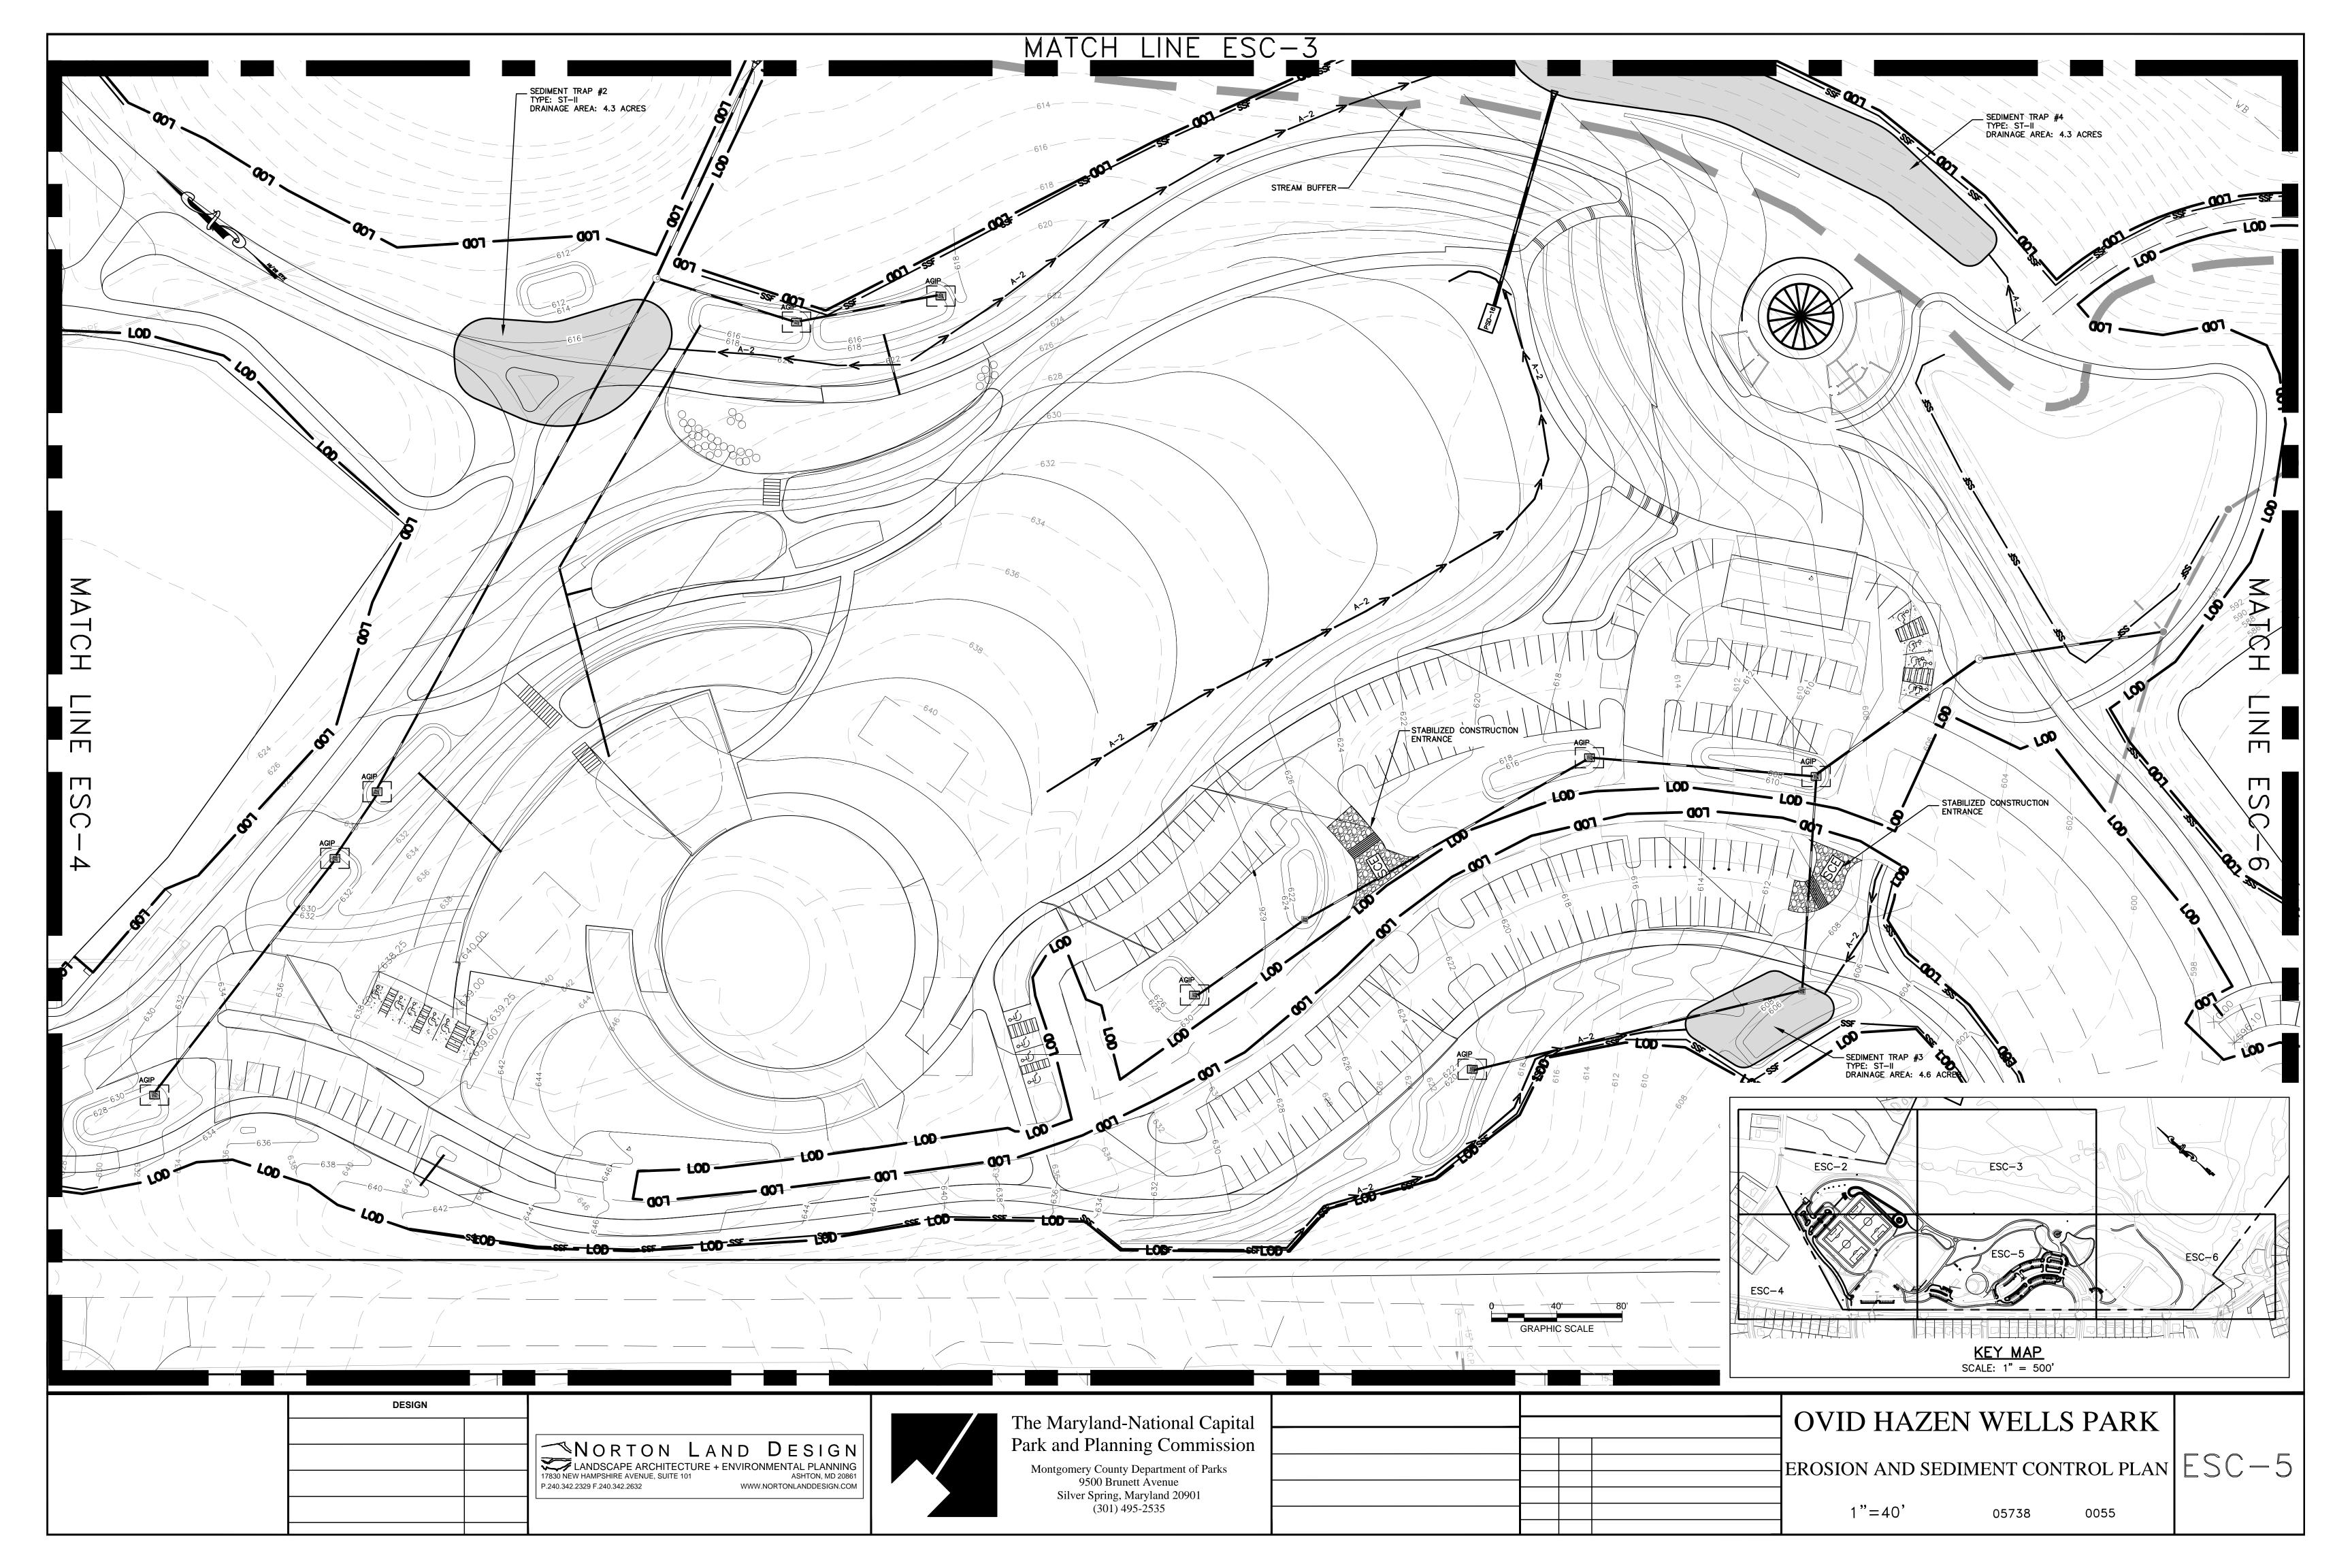
SWM-7










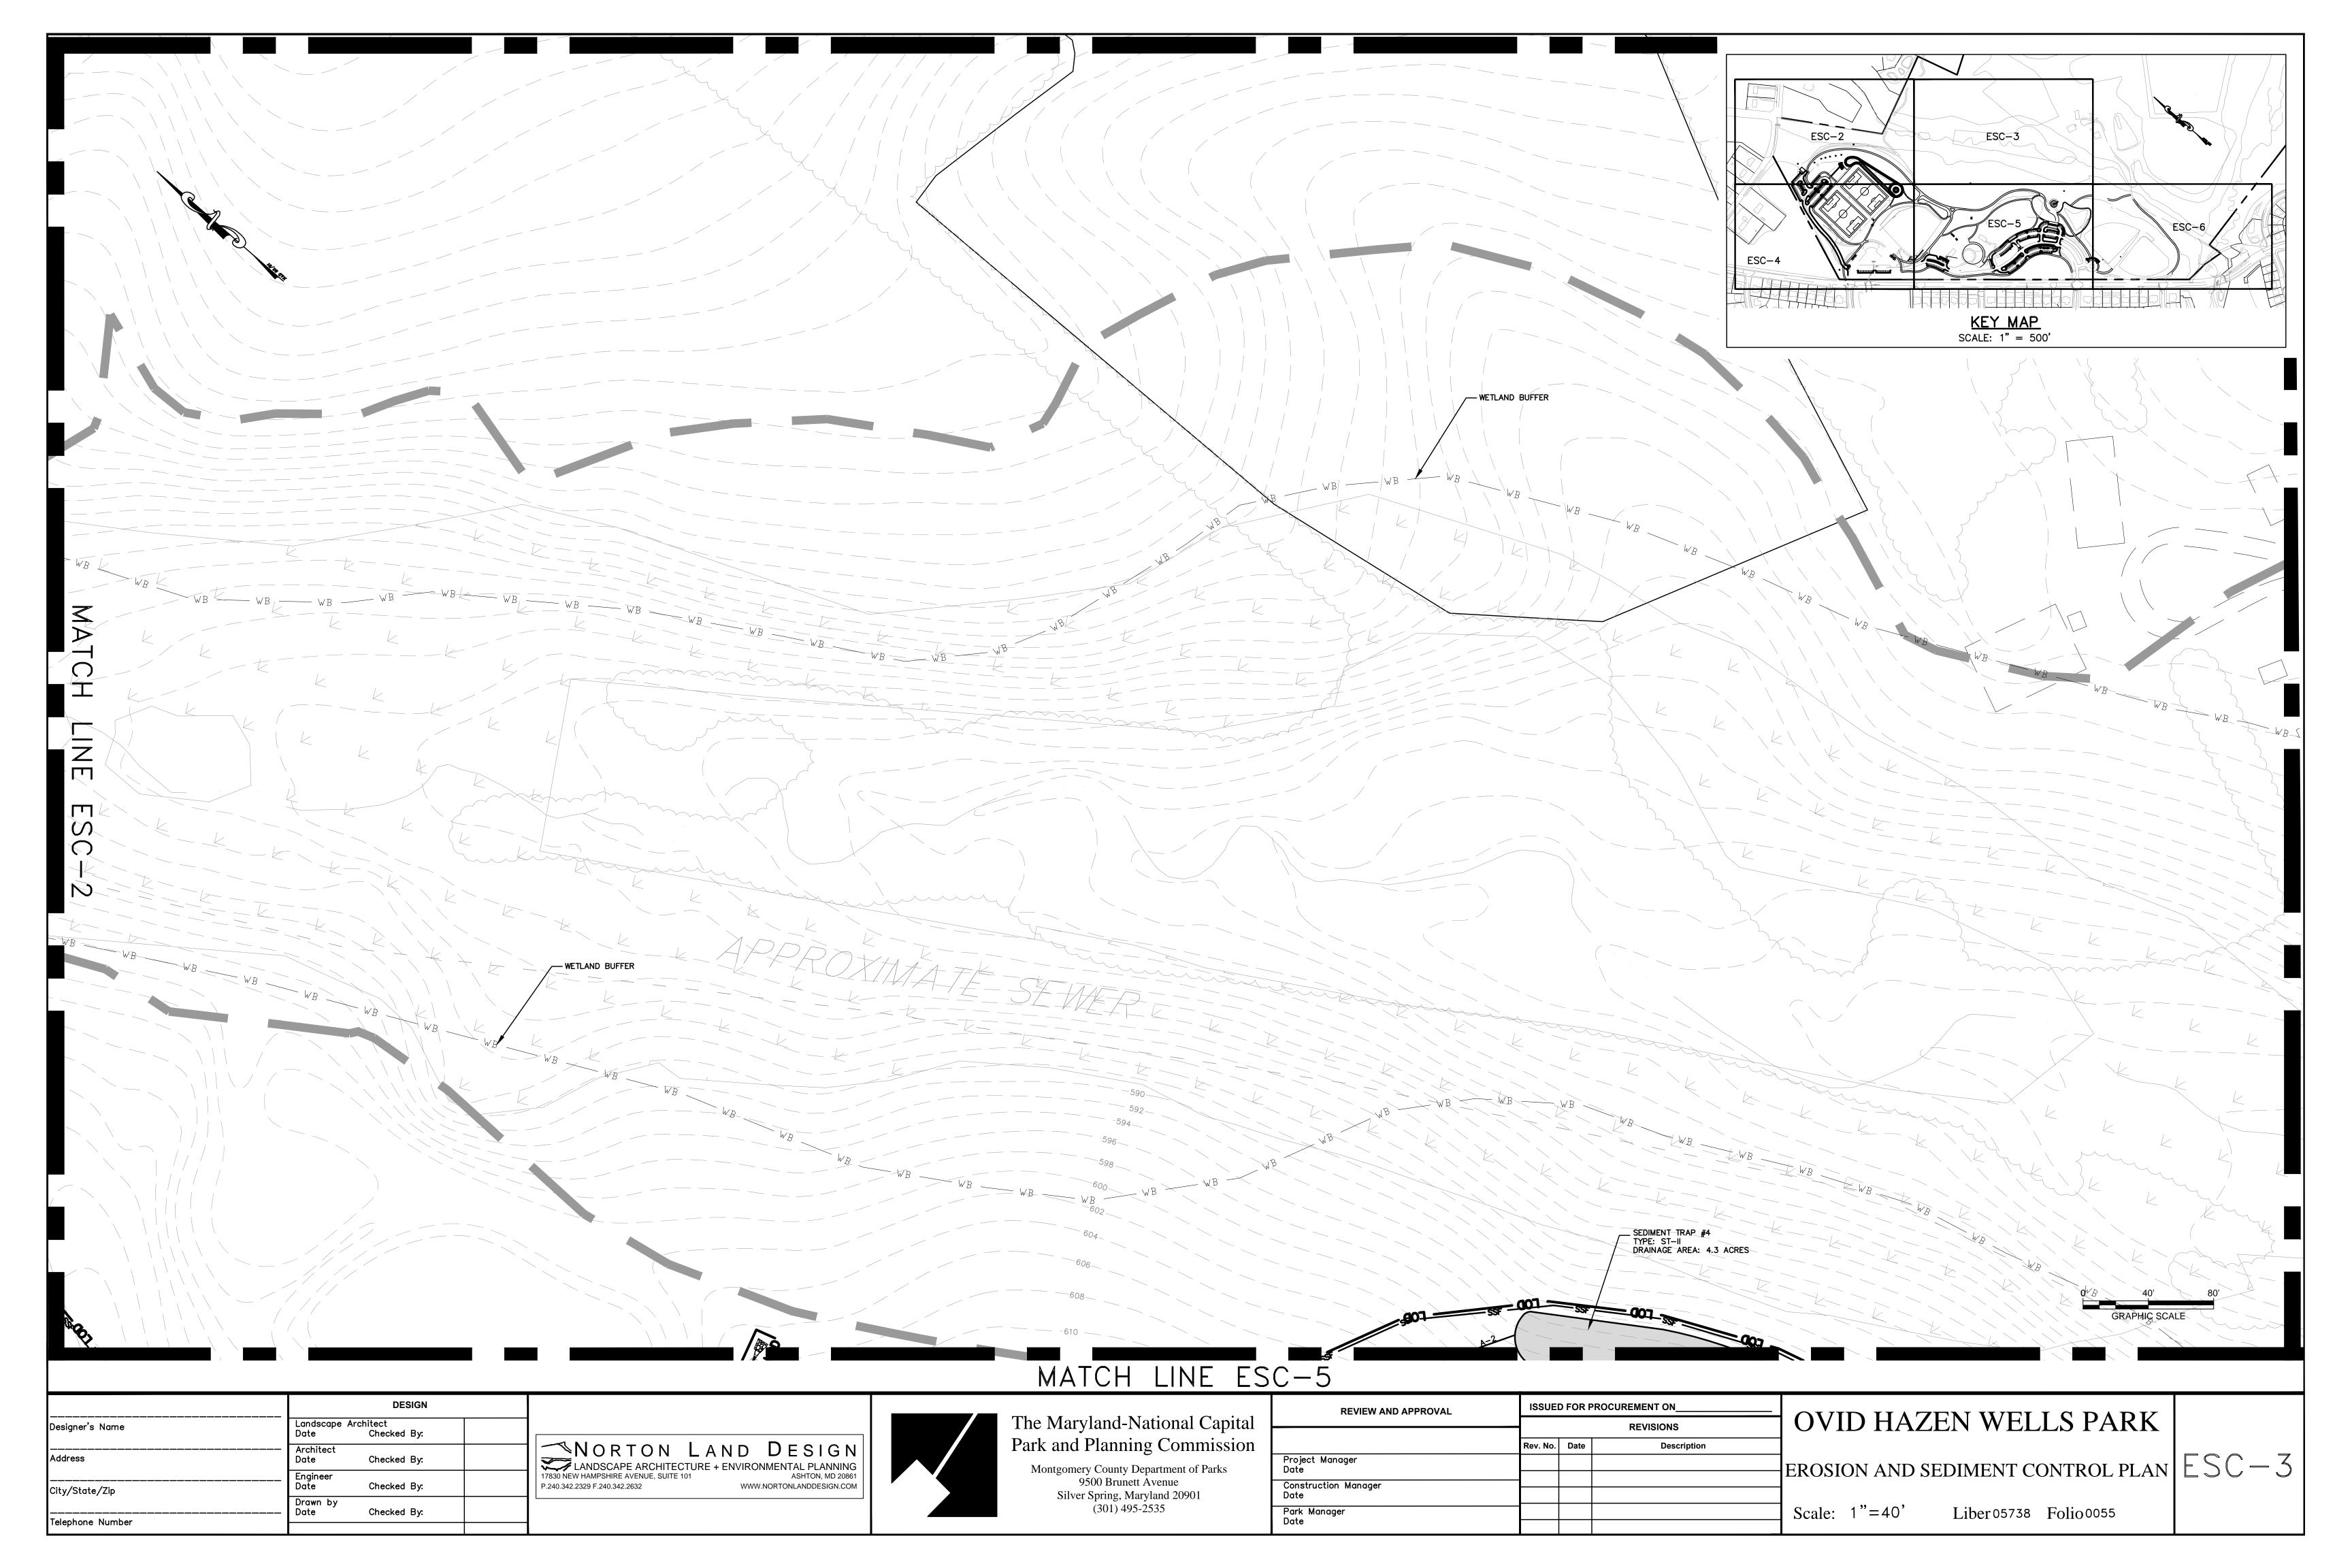

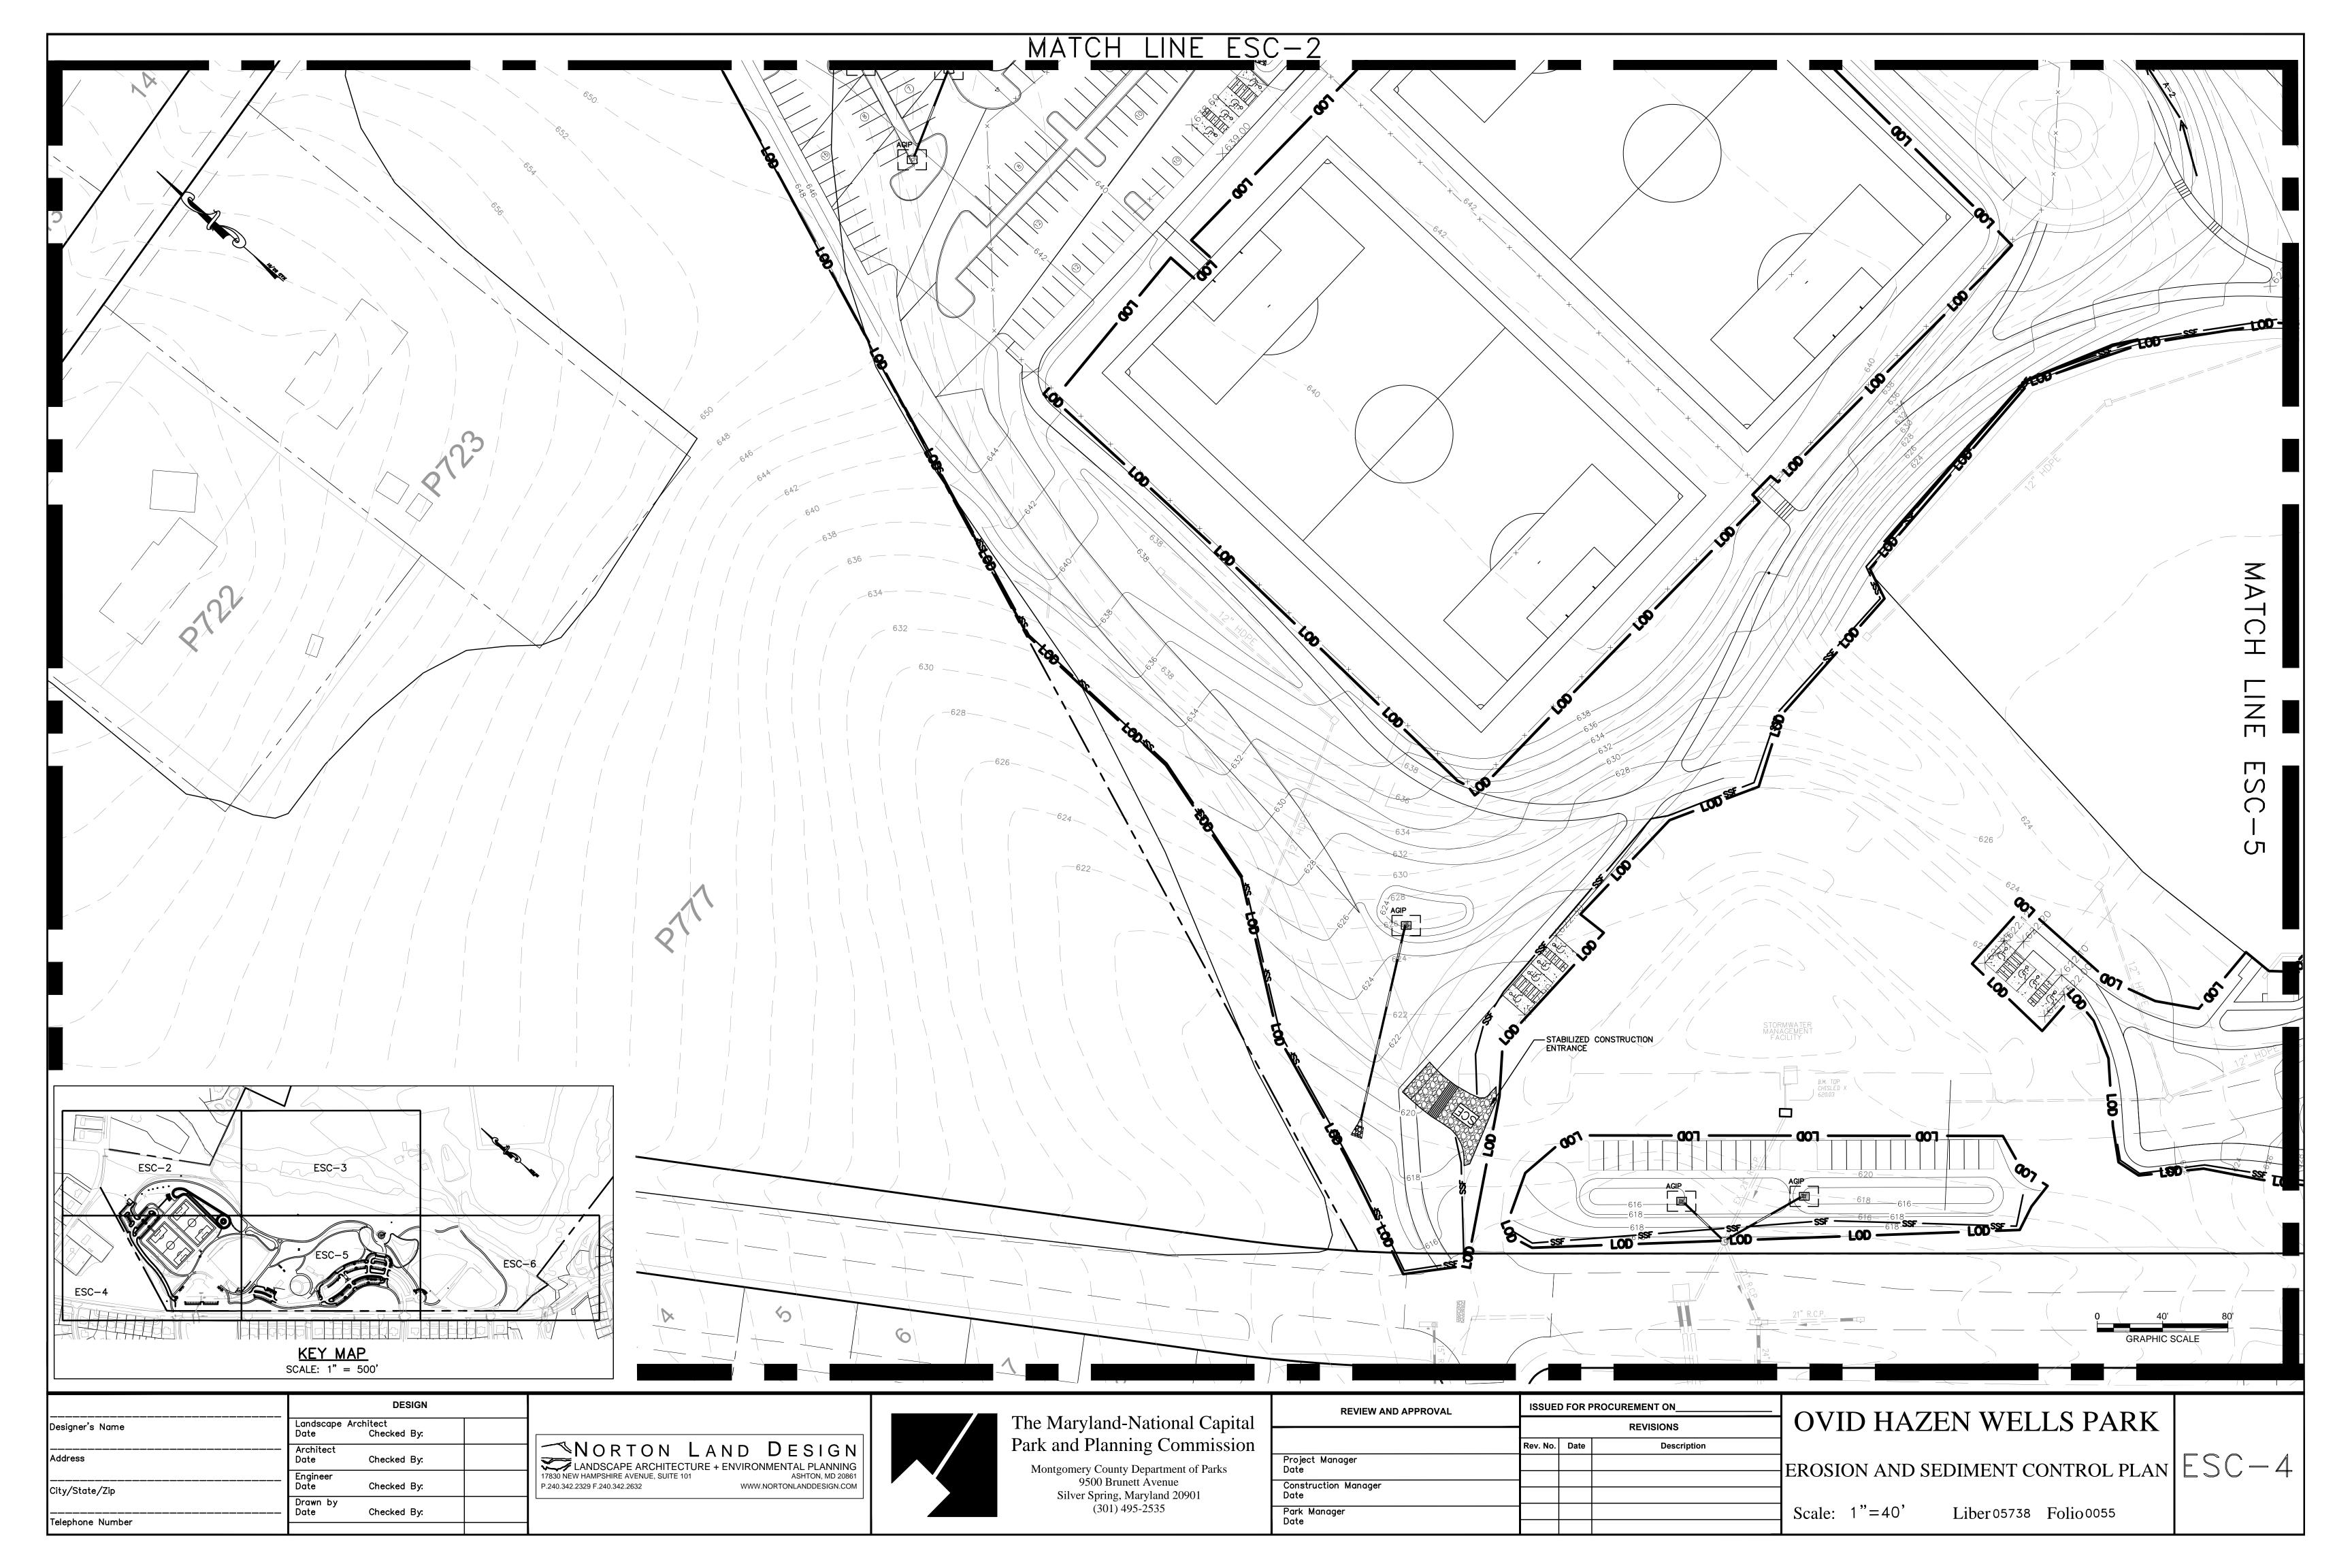


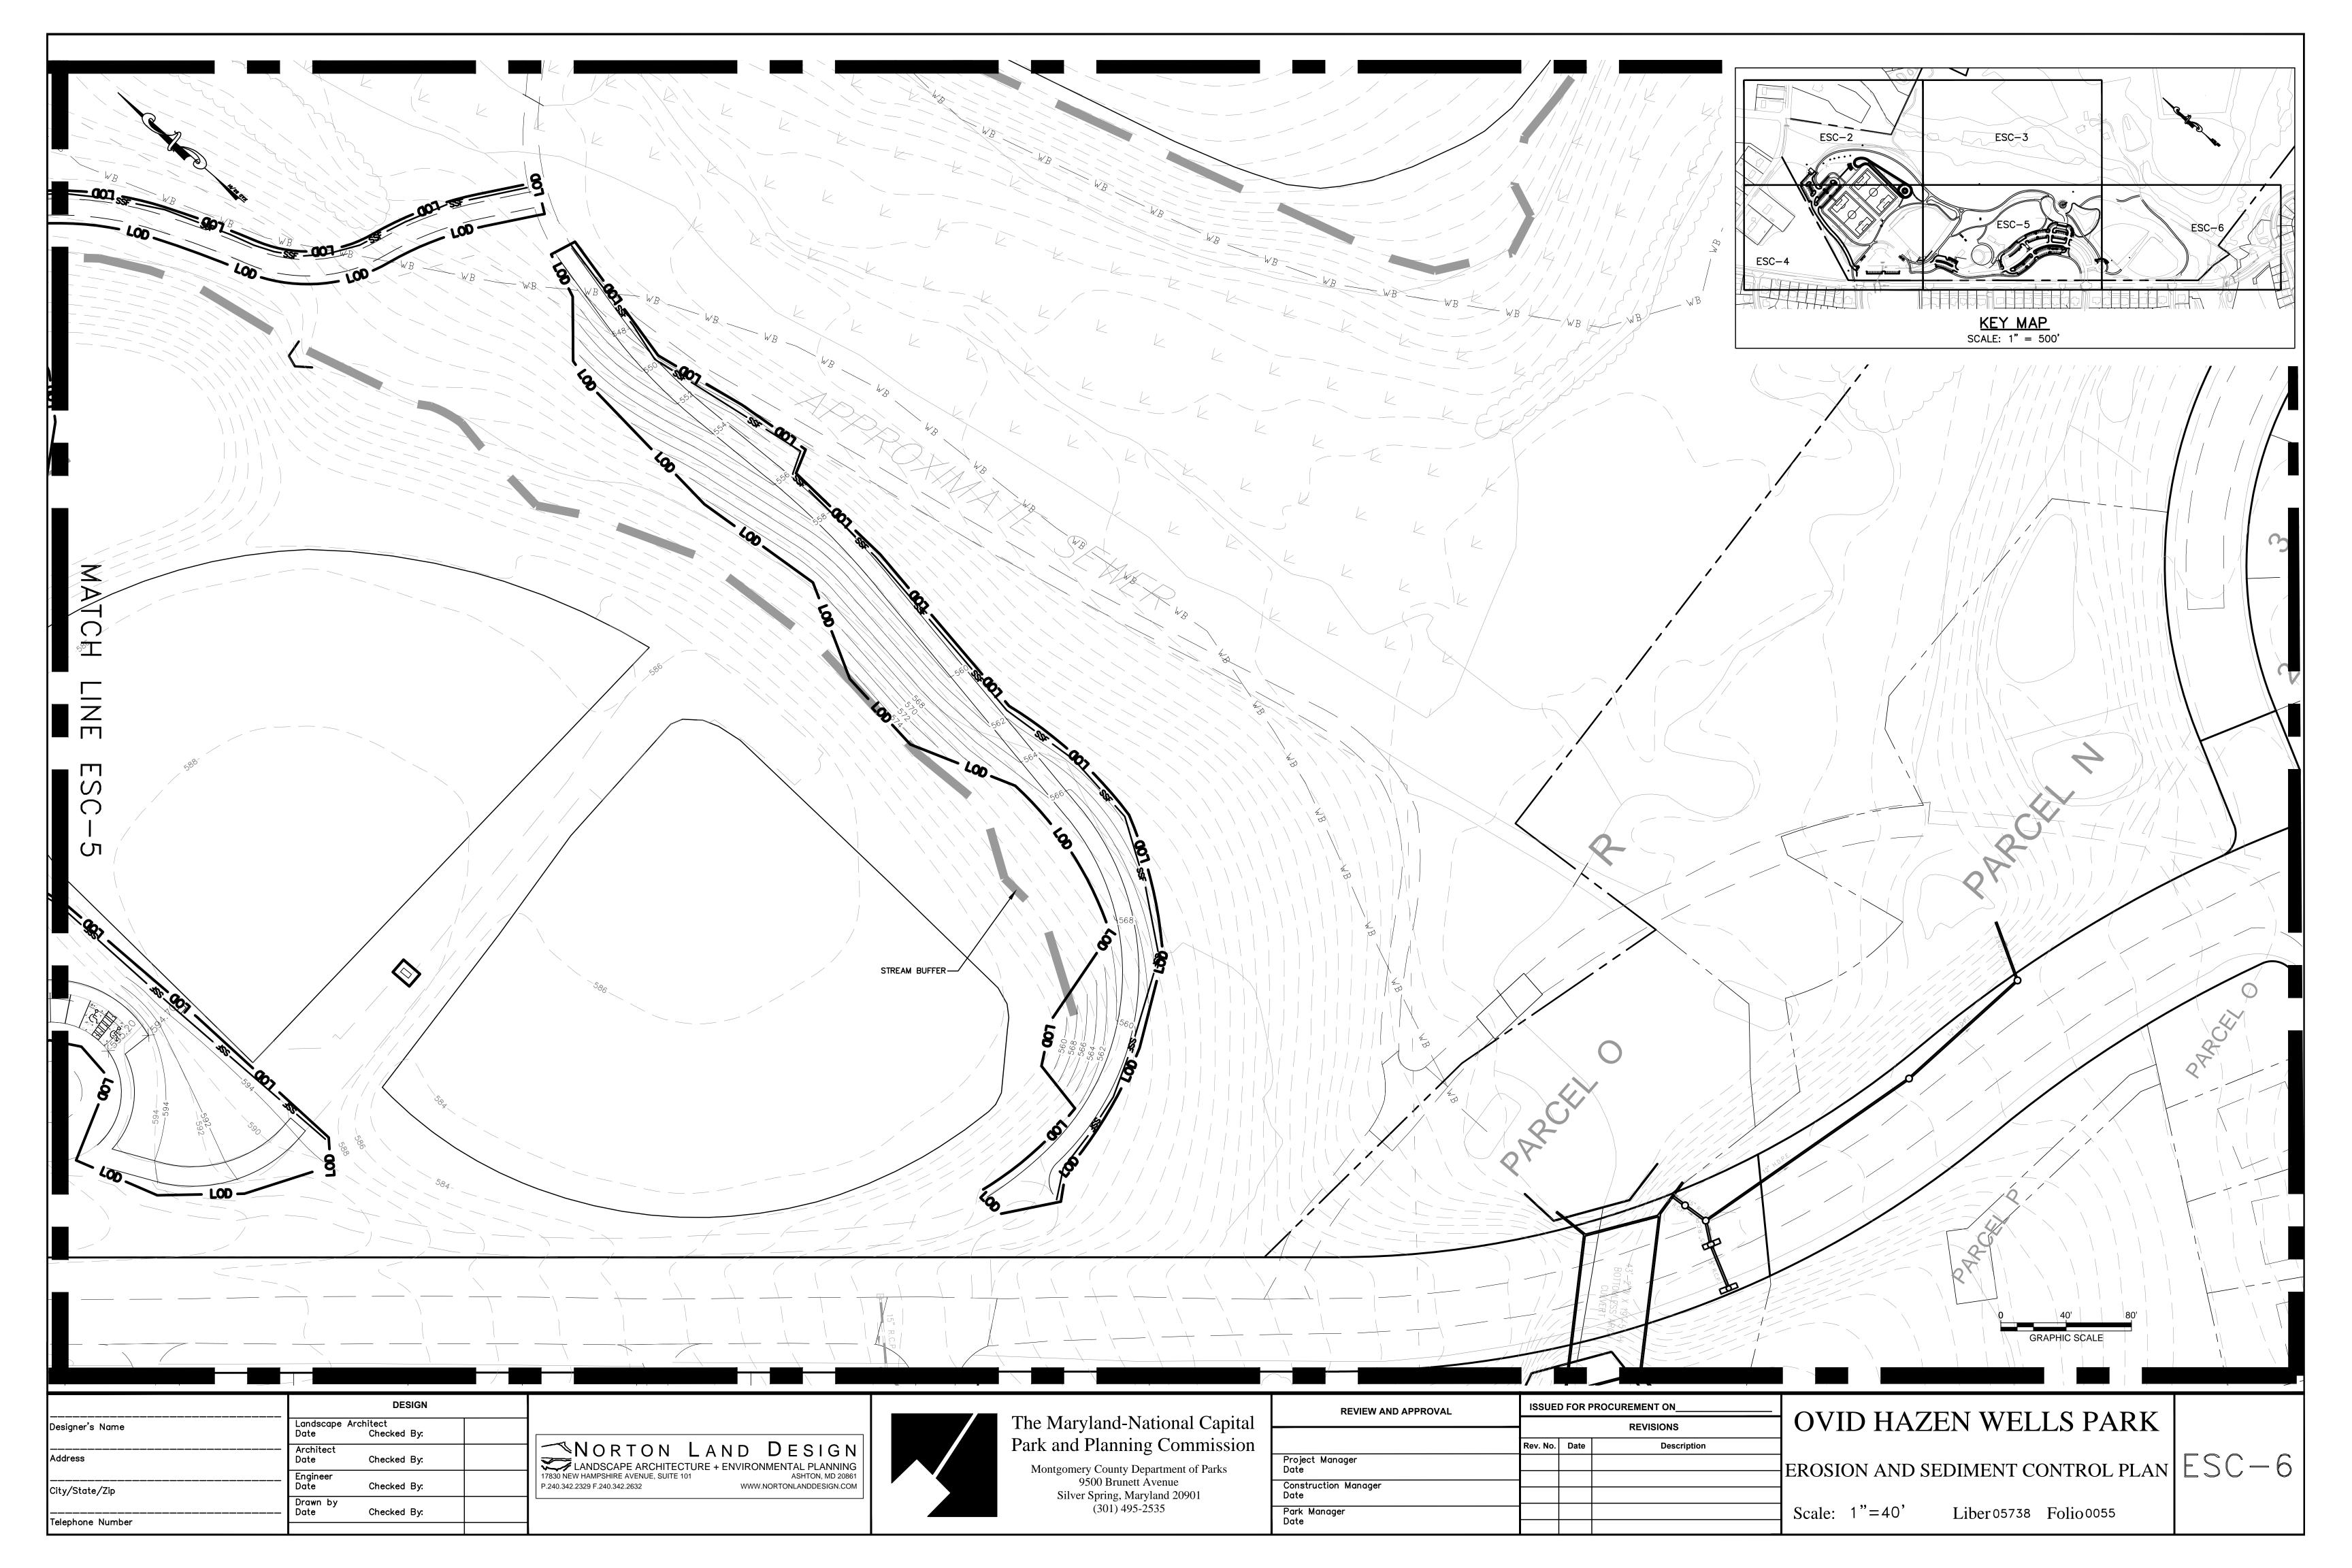


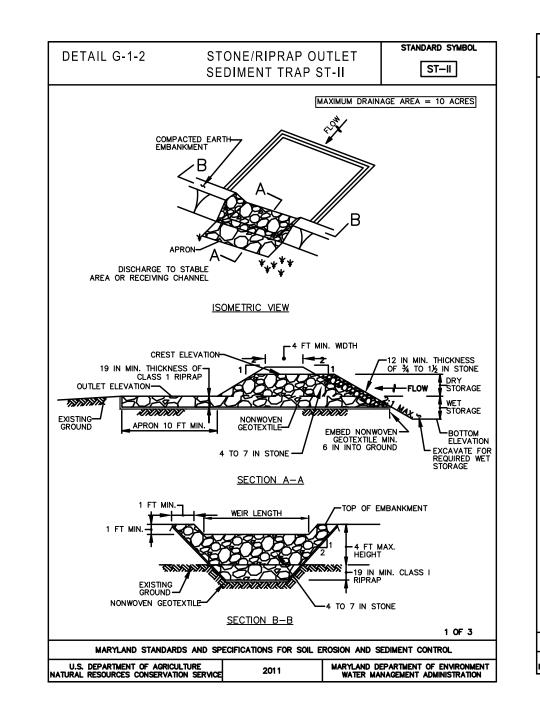

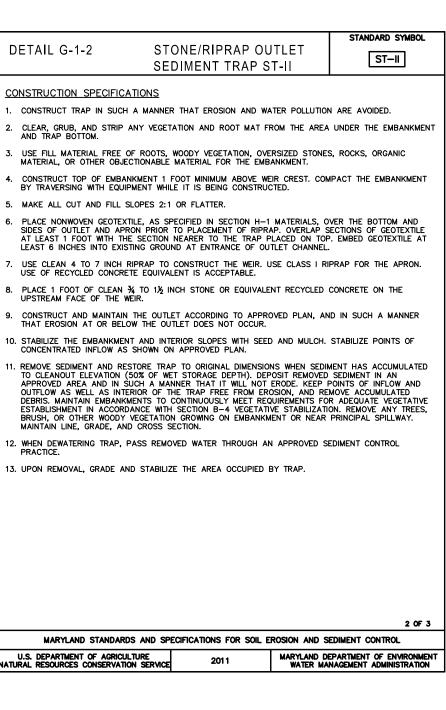

DETAIL G-1-2		RIPRAP OUTLET	STANDARD SYMI	3OL
STONE/RIPRAP	OUTLET SEDIME	NT TRAP ST-II, TRA	AP NO	
DRAINAGE AREA — INITIAL			ACRES	
DRAINAGE AREA - INTERIM			ACRES	
DRAINAGE AREA - FINAL			ACRES	
TOTAL STORAGE REQUIRED			CF	
TOTAL STORAGE PROVIDED			CF	
WET STORAGE REQUIRED			CF	
WET STORAGE PROVIDED			CF	
DRY STORAGE REQUIRED			CF	
DRY STORAGE PROVIDED			CF	\Box
EXISTING GROUND ELEVATION (WET STORAGE ELEVATION)	N AT OUTLET		FT	
TRAP BOTTOM ELEVATION			FT	
TRAP BOTTOM DIMENSIONS			FT x FT	
WEIR LENGTH			FT	
WEIR CREST (DRY STORAGE) ELEVATION		FT	П
CLEANOUT ELEVATION			FT	
TOP OF EMBANKMENT ELEV	ATION		FT	
SIDE SLOPE			H: V RATIO	
EMBANKMENT TOP WIDTH			FT	
OUTLET PROTECTION - LEN	GTH		FT	П
OUTLET PROTECTION - DEP	TH		IN	\neg
MARYLAND STANDARD	S AND SPECIFICATIO	NS FOR SOIL EROSION A	AND SEDIMENT CONTROL	3 OF
U.S. DEPARTMENT OF AGRICUL	TURE	2011 MARYLA	ND DEPARTMENT OF ENVIRO	NMEN

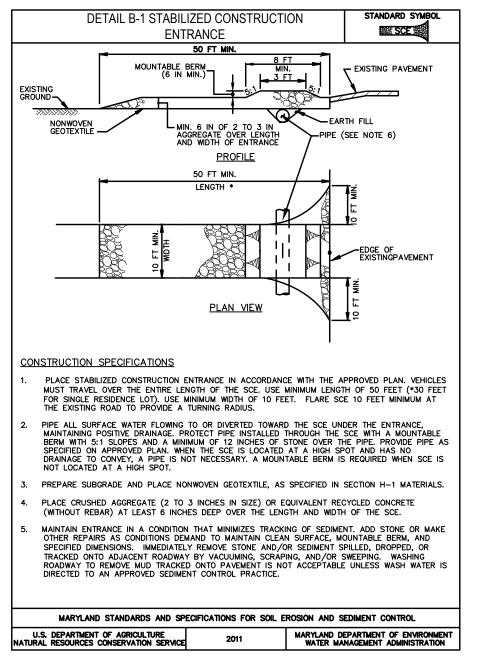

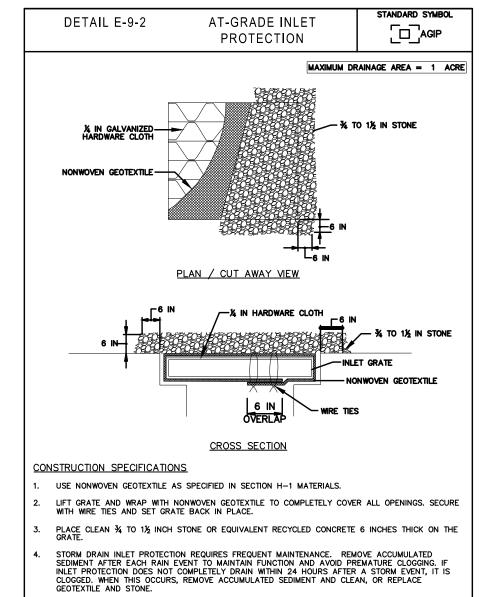


MARYLAND STANDARDS AND SPECIFICATIONS FOR SOIL EROSION AND SEDIMENT CONTROL


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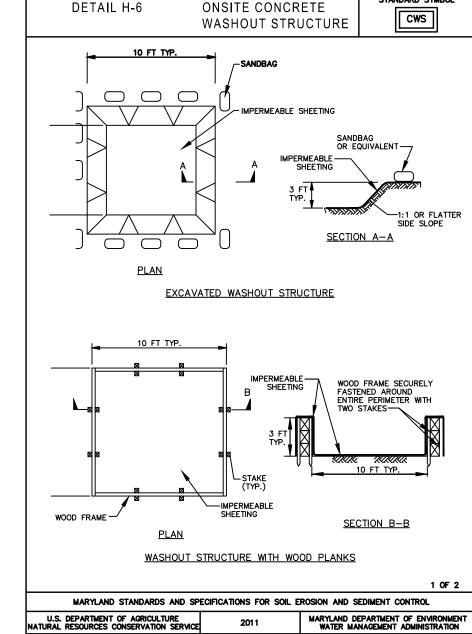
DETAIL D-1


MARYLAND DEPARTMENT OF ENVIRONMEN WATER MANAGEMENT ADMINISTRATION

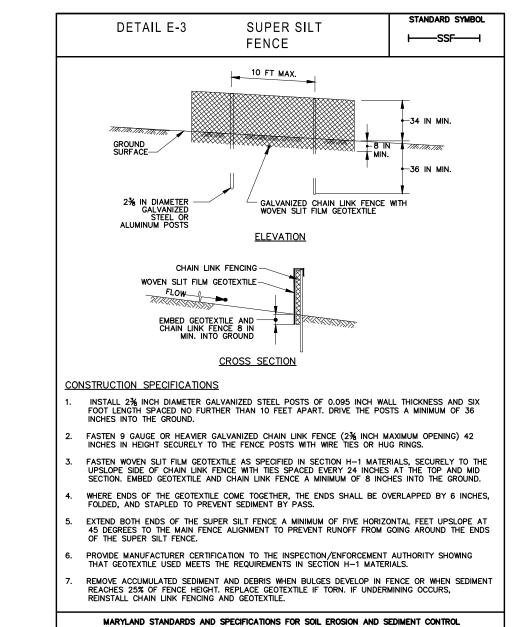



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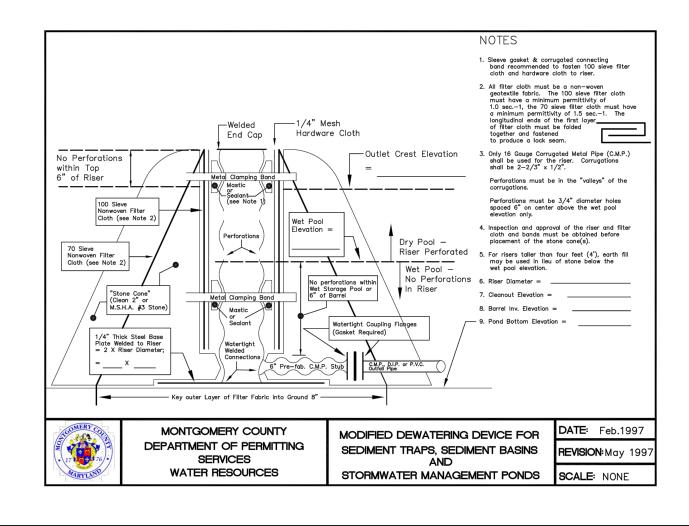




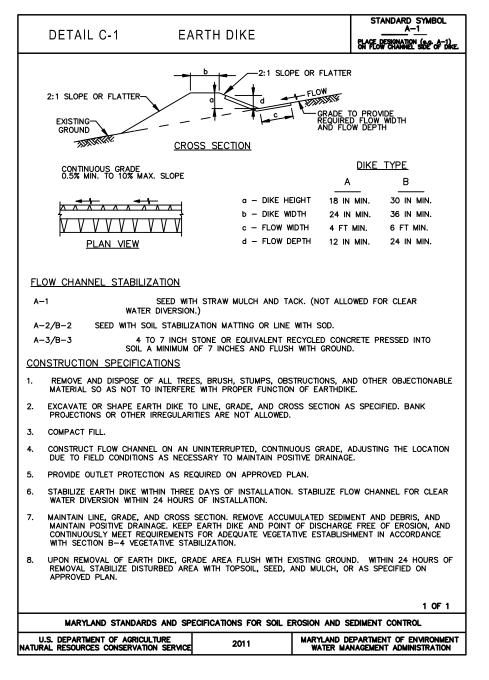

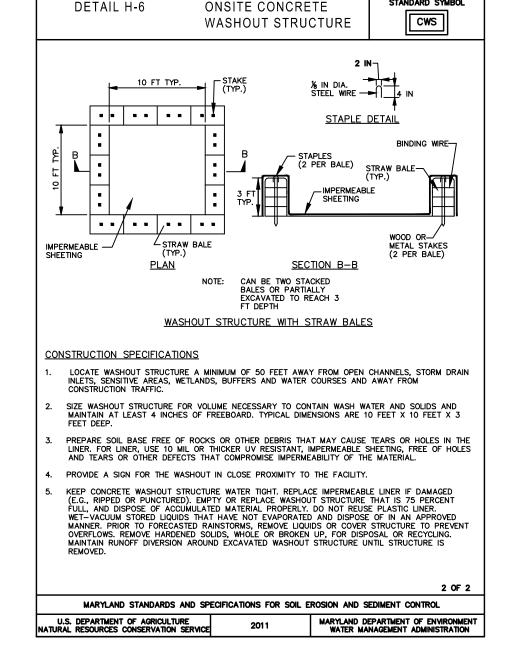

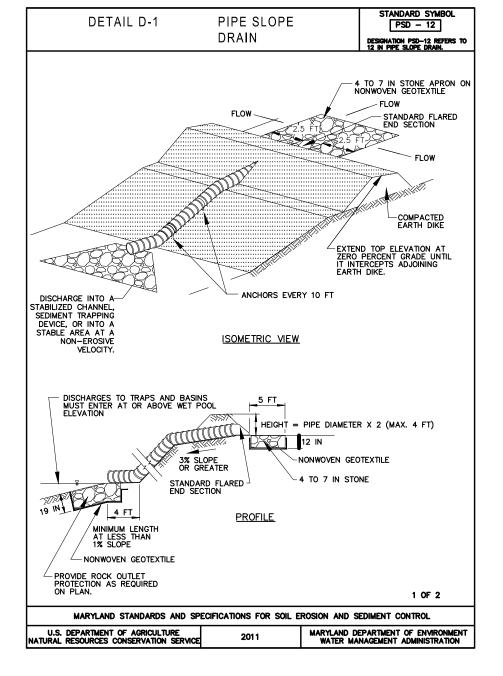

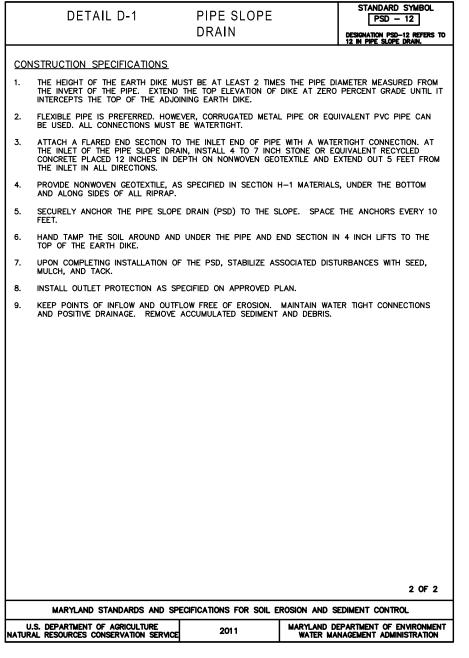

		DESIGN	
Designer's Name	Landscape A	Architect Checked By:	1
Address	Architect Date	Checked By:	
 City/State/Zip	Engineer Date	Checked By:	
Telephone Number	Drawn by Date	Checked By:	

NORTON LAND DESIGN LANDSCAPE ARCHITECTURE + ENVIRONMENTAL PLANNING 17830 NEW HAMPSHIRE AVENUE, SUITE 101 ASHTON, MD 20861 P.240.342.2329 F.240.342.2632 WWW.NORTONLANDDESIGN.COM



The Maryland-National Capital Park and Planning Commission

Montgomery County Department of Parks 9500 Brunett Avenue Silver Spring, Maryland 20901 (301) 495-2535

REVIEW AND APPROVAL	ISSUED FOR PROCUREMENT ON				
		REVISIONS			
	Rev. No.	Date	Description	1	
Project Manager Date				J	
Construction Manager Date					
Park Manager Date				So	

OVID HAZEN WELLS PARK **EROSION AND SEDIMENT CONTROL DETAILS**

Liber 05738 Folio 0055 Scale: N/A

ESC-7

