MCPB Item No.

Date: 01-21-16

Muncaster Mill Road Sidewalk, Mandatory Referral, MR2016012



Joshua Penn, Planner Coordinator, <u>Joshua.Penn@montgomeryplanning.org</u>, 301-495-4546



Frederick Vernon Boyd, Master Planner Supervisor, Fred.Boyd@montgomeryplanning.org, 301-495-4654

Kipling Reynolds AICP, Chief Area 3, Kipling.Reynolds@montgomeryplanning.org, 301-495-4645


Completed: 1/8/16

Description

A. Mandatory Referral 2016012, Muncaster Mill Road Sidewalk

Construction of approximately 800 feet of six-foot-wide sidewalk along the north side of Muncaster Mill Road from Needwood Road to Colonel Zadok Magruder High School in Derwood. Upper Rock Creek Master Plan (2004)

- Master Plans: 2004 Upper Rock Creek
- Applicant: Montgomery County Department of Transportation
- Filing Date: November 23, 2015

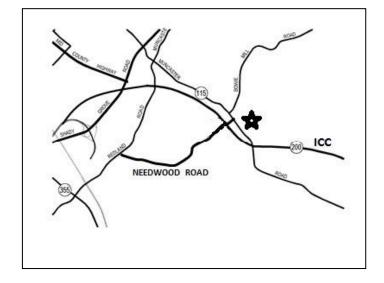

Summary

- The review of this Mandatory Referral is in two parts:
 Item 4A Mandatory Referral MR2016012, and
 Item 4B Preliminary/Final Water Quality Plan MR2016012 discussed as a separate staff report.
- Staff recommends approval of the Mandatory Referral with comments to be transmitted to the Montgomery County Department of Transportation (Item 4A).
- This project is located within the Upper Rock Creek Special Protection Area (SPA) and on publicly owned property. Approval of a water quality plan is required under Section 19-62 of the Montgomery County Code. The Planning Board must take separate action on the Preliminary/Final Water Quality Plan (Item 4B) prior to taking action on the Mandatory Referral.
- This sidewalk will provide a connection between the Needwood Road Bikepath and Colonel Zadok Magruder High School where no current or proposed access exists.

RECOMMENDATIONS:

Transmit the following comments to the Montgomery County Department of Transportation:

- 1. The project must adhere to the approved Forest Conservation Plan Exemption/Tree Save Plan and Preliminary/Final Water Quality Plan.
- 2. Pedestrian scale lighting, or at the very least high-mount cobra lighting, on decorative poles is recommended for the extent of the project.
- 3. The sidewalk at the southeast corner of Needwood Road should be constructed behind the handicap ramp rather than through it so that waiting pedestrians are farther away from traffic.
- 4. Since Muncaster Mill Road is an arterial with an average annual daily traffic volume of 19,462 vehicle trips (SHA 2014 data), the sidewalk in the northern half of the project should be offset from the curb for pedestrian safety and comfort, similar to what is proposed for the southern half of the project and to be consistent with County standards.
- 5. Consider striping crosswalk for the north driveway, similar to what is proposed for the south driveway.
- 6. Consider constructing the lead sidewalk at the school on the north side of the driveway rather than the south side to:
 - i. Provide a shorter crossing for pedestrians;
 - ii. Allow pedestrians to cross the driveway farther away from fast moving traffic; and
 - iii. Reduce impacts to the root zone of the 54-inch tree.

Previous Board Actions

The Muncaster Mill Road Sidewalk was previously included in the application and staff report for MR2015021 Needwood Road Bikepath, which went to the Planning Board on June 18, 2015. Phase 2 of that project originally included a sidewalk along Muncaster Mill Road from Needwood Road to Colonel Zadok Magruder High School, but since a Water Quality Plan had not yet been prepared, MCDOT requested that the sidewalk be dropped from the project being reviewed by the Board. That project was approved with comments and recommendations.

Mandatory Referral Review

The Montgomery County Department of Transportation (MCDOT) proposal for the construction of the approximately 800 feet of six-foot-wide sidewalk along the north side of Muncaster Mill Road from Needwood Road to Colonel Zadok Magruder High School requires the Mandatory Referral review process under the Montgomery County Planning Department's Uniform Standards for Mandatory Referral Review. State law requires all federal, state, and local governments and public utilities to submit proposed projects for a Mandatory Referral review and approval by the Commission. The law requires the Planning Board to review and approve the proposed location, character, grade and extent of any road, park, public way or ground, public (including federal) building or structure, or public utility (whether publicly or privately owned) prior to the project being located, constructed or authorized.

The Montgomery County Forest Conservation Law is applicable to the project; however the project qualifies for, and has been granted, an exemption by Planning Department Staff (#42015127E) under the provisions of Section 22A-5(e) as "a State or County highway construction activity..." In addition, the project is located in the Upper Rock Creek Special Protection Area and is therefore subject to Water

Quality Plan requirements. A summary of this review is provided in this staff report with a more complete analysis provided in the associated Preliminary/Final Water Quality Plan staff report (Item 4B).

Site Description

The project study area includes approximately 1,000 feet along the north side of Muncaster Mill Road from Needwood Road to Colonel Zadok Magruder High School in Derwood. Muncaster Mill Road is classified in the 2004 Upper Rock Creek Master Plan as an arterial road. The road is posted at 40 miles per hour. The majority of the road remains as a two lane road except where development projects have been required to widen the road and at intersections where turn lanes have been provided.

Project Description

Construction of a six-foot-wide sidewalk along the north side of Muncaster Mill Road from Needwood Road to Colonel Zadok Magruder High School will connect the Needwood Road Bikepath (Class I shared use) with a safe and convenient pedestrian and bicycle route to the high school. The project includes the design and construction of new six-foot-wide sidewalk.

Master Plan Consistency

The Upper Rock Creek Master Plan (2004) classifies Needwood Road as a two-lane Primary Residential Street (P-8) in a minimum 70-foot right-of-way. The Countywide Bikeways Functional Master Plan (2005) recommends that Needwood Road have both bike lanes and a shared use path (DB-14).

The Master Plan recommends safe walking routes to local destinations such as schools. This project provides a safe walking route from a Class I Bikepath (shared use) along Needwood Road to Colonel Zadok Magruder High School via Muncaster Mill Road.

The project is consistent with the recommendations in the Master Plan.

Public Meetings

A notice of the Mandatory Referral was sent to area citizens associations. In addition, MCDOT has held Public Meetings on January 8, 2015 and April 15, 2015.

Impacts to Parkland

This application has no impacts on Parkland.

ENVIRONMENT

Environmental Guidelines

The project area does not contain any environmental buffers, streams, other sensitive features. It is located in the Upper Rock Creek Master Plan area, the Upper Rock Creek Special Protection Area, and within the Upper Rock Creek watershed, which is classified by the State of Maryland as Use Class III waters. The project is in compliance with the Environmental Guidelines.

Forest Conservation

The Application meets the requirements of Chapter 22A of the Montgomery County Forest Conservation Law. See the Preliminary/Final Water Quality Plan staff report (Item 4B) for a complete analysis.

Special Protection Areas (SPA) Water Quality Plan

This project is located within the Upper Rock creek SPA and on publicly owned property. The Mandatory Referral project is required to obtain approval of a water quality plan under Section 19-62 of the Montgomery County Code. See the Preliminary/Final Water Quality Plan staff report (Item 4B) for a complete analysis.

CONCLUSION

Staff recommends that the Planning Board approves the Mandatory Referral and transmits recommendations as specified on page two of this staff report.

ATTACHMENTS

- A. MCDOT Mandatory Referral Request
- B. Needwood Road Bikepath/Trail: Muncaster Mill Road Sidewalk SPA Plan



NOV 2 3 2015

MONTGOMERY COUNTY PLANNING DEPARTMENT Roshdieh

Acting Director

Isiah Leggett
County Executive

November 20, 2015

Casey Anderson, Planning Board Chair The Maryland-National Capital Park and Planning Commission Montgomery County Planning Board 8787 Georgia Avenue Silver Spring, Maryland 20910

Re: Needwood Road Bike Path Trail/

Muncaster Mill Road Sidewalk

CIP No. 501304

Request for Mandatory Referral

Upper Rock Creek

Special Protection Area (SPA)

Dear Mr. Anderson:

This letter is to request your agency's review of the above referenced project for Mandatory Referral.

The Montgomery County Department of Transportation (MCDOT) proposes a six feet wide concrete sidewalk along the east side of Muncaster Mill Road (MD 115) from the intersection with Needwood Road to the northern entrance at Colonel Zadok Magruder High School in Derwood.

The project is located in Upper Rock Creek SPA. The project provides an 800 feet long concrete sidewalk with a varying width of grass buffer (eight-foot maximum) between the curb and the sidewalk. The project provides one bio-swale, one rain garden and a non-rooftop runoff disconnection for SWM/ESD design for the project.

The project will provide a safe transportation facility for pedestrians traveling to Colonel Zadok Magruder High School. This project is a part of Needwood Road Bike Path Phase II that was approved by the Board for Mandatory Referral on June 18, 2015. However, because the proposed sidewalk is located in SPA, the sidewalk portion is handled separately from the rest of the Needwood Road Bike Path project for Mandatory Referral.

Maryland Historical Trust determined that there are no historic properties affected by the project according to their response, dated October 7, 2014. The Department of Parks also confirmed the same determination on November 17, 2014.

Division of Transportation Engineering

100 Edison Park Drive, 4th Floor • Gaithersburg, Maryland 20878 • 240-777-7220 • 240-777-7277 www.montgomerycountymd.gov



Mr. Anderson November 20, 2015 Page 2 of 2

The Forest Conservation Exemption Plan No. 42015194E for the project was approved on May 4, 2015. The pre-application meeting took place on August 13, 2015 and its meeting minutes were approved by Department of Permitting Services on September 22, 2015. In addition, the preliminary and final water quality plan for the project was approved on November 2, 2015.

The project design is scheduled to be completed in winter 2016. The construction for the sidewalk along with the rest of Phase II is scheduled to start in spring, 2017. The construction duration is anticipated to be ten months.

The Needwood Road Bikepath-Phase II capital improvement project is funded solely by the County's General Obligation bonds.

If you have any questions regarding this project, please contact Rebecca Park, P.E., Project Manager, at 240-777-7263 or at rebecca.park@montgomerycountymd.gov.

Sincerely,

Bruce E. Johnston, P.E.

Chief

BEJ:gl

Enclosures

cc: Dan Sheridan, P.E., MCDOT-Transportation Planning and Design Section Rebecca Park, P.E., MCDOT-Transportation Planning and Design Section

MONTGOMERY COUNTY DEPARTMENT OF TRANSPORTATION

NEEDWOOD ROAD

INDEX OF SHEETS

		
SHT.NO.	DWG.NO.	DWG. DESCRIPTION
01	GN-01	TITLE SHEET
02	TS-02	TYPICAL SECTIONS
03-04	PS-07-08	ROADWAY PLANS
05	SC-01	EROSION & SEDIMENT CONTROL NOTES
06	SC-02	EROSION & SEDIMENT CONTROL DETAILS
07	SC-03	EROSION & SEDIMENT CONTROL PLAN
08	SWM-01	STORMWATER MANAGEMENT PLAN
09	SWM-02	STORMWATER MANAGEMENT DETAILS

BIKE PATH/TRAIL SPECIAL PROTECTION AREA

C. I. P. PROJECT NO. 501304

MUNCASTER MILL ROAD

SPA DESIGN

MONTGOMERY COUNTY DEPARTMENT OF TRANSPORTATION MAINTENANCE CERTIFICATION

I HEREBY CERTIFY THAT THE DEPARTMENT OF TRANSPORTATION WILL ASSUME MAINTENANCE RESPONSIBILITIES FOR ALL STORMWATER MANAGEMENT FACILITIES AS LISTED AND SHOWN, HEREON, IN ACCORDANCE PLANNED THAT WOULD IMPACT ANY OF THE STORMWATER MANAGEMENT FACILITIES INCLUDED HEREIN, THIS DEPARTMENT WILL NOTIFY THE DEPARTMENT OF ENVIRONMENTAL PROTECTION DURING THE PLANNING OR EARLY DESIGN STAGE FOR SUCH IMPROVEMENTS.

DATE

BRUCE E. JOHNSTON, P.E. CHIEF. DIVISION OF TRANSPORTATION ENGINEERING

OWNER'S CERTIFICATION

I HEREBY CERTIFY THAT ALL CLEARING, GRADING, CONSTRUCTION AND/OR DEVELOPMENT WILL BE DONE PURSUANT TO THIS PLAN AND THAT ANY RESPONSIBLE PERSONNEL INVOLVED IN THE CONSTRUCTION PROJECT WILL HAVE A CERTIFICATE OF ATTENDANCE AT A DEPARTMENT OF NATURAL RESOURCES APPROVED TRAINING PROGRAM FOR THE CONTROL OF SEDIMENT AND EROSION BEFORE BEGINNING THE PROJECT.

DATE

BRUCE E. JOHNSTON, P.E. CHIEF, DIVISION OF TRANSPORTATION ENGINEERING

DESIGN CERTIFICATION

I HEREBY CERTIFY THAT THIS PLAN HAS BEEN PREPARED IN ACCORDANCE WITH THE "2011 MARYLAND" STANDARDS AND SPECIFICATION FOR SOIL EROSION AND SEDIMENT CONTROL," MONTGOMERY COUNTY DEPARTMENT OF PERMITTING SERVICES EXECUTIVE REGULATIONS 5-90, 7-02AM AND 36-90, AND MONTGOMERY COUNTY DEPARTMENT OF PUBLIC WORKS AND TRANSPORTATION "STORM DRAIN CRITERIA" DATED AUGUST, 1988.

DATE


MICHAEL ROTHENHEBER, P.E. MD. REGISTRATION NO. 18589

CERTIFICATION OF THE QUANTITIES

I HEREBY CERTIFY THAT THE ESTIMATED TOTAL AMOUNT OF EXCAVATION AND FILL AS SHOWN ON THESE PLANS HAS BEEN COMPUTED TO 607 CUBIC YARDS OF EXCAVATION, 40 CUBIC YARDS OF FILL AND THE TOTAL AREA TO BE DISTURBED AS SHOWN ON THESE PLANS HAS BEEN DETERMINED TO BE 137,400 SQUARE FEET OR 3.2 ACRES.

DATE

MICHAEL ROTHENHEBER, P.E. MD. REGISTRATION NO. 18589

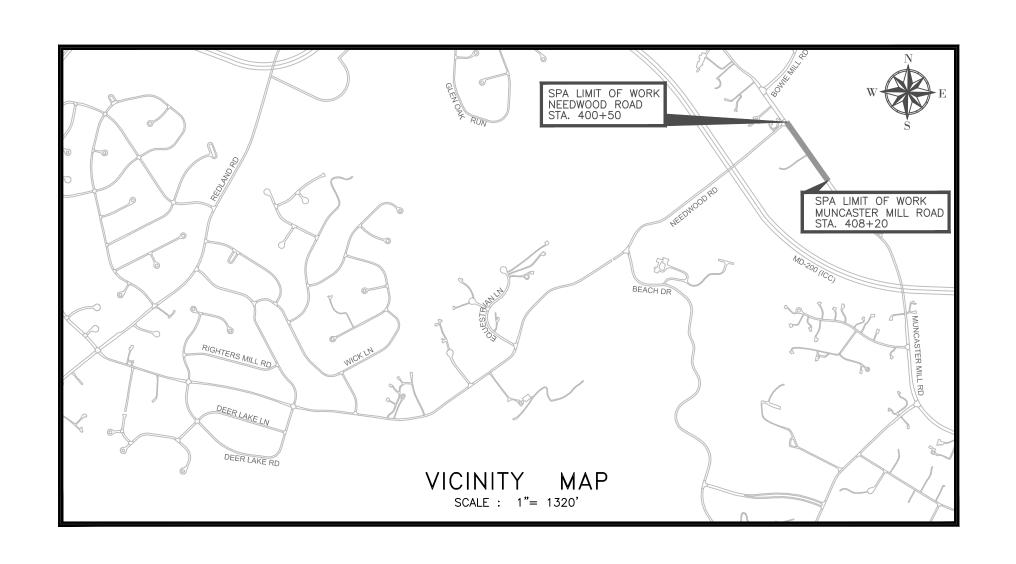

PROFESSIONAL CERTIFICATION

I HEREBY CERTIFY THAT THESE DOCUMENTS WERE PREPARED OR APPROVED BY ME, AND THAT I AM A DULY LICENSED PROFESSIONAL ENGINEER UNDER THE LAWS OF THE STATE OF MARYLAND. LICENSE NO. _____ EXPIRATION DATE _____

FOR THE PURPOSE OF MANDATORY REFERRAL: SPA ONLY

JOHNSON, MIRMIRAN & THOMPSON Engineering A Brighter Future®			
72 Loveton Circle, Sparks, MD 21152 Telephone: (410) 329-3100; Fax: (410) 472-2200; WEB: WWW.JMT.COM			

OWNER/ADDRESS:
MONTGOMERY COUNTY DEPARTMENT
OF TRANSPORTATION
100 EDISON PARK DRIVE, 4TH FLOOR
GAITHERSBURG, MD 20878

REBECCA PARK, P.E. PROJECT MANAGER DESIGN SECTION
DIVISION OF TRANSPORTATION ENGINEERING 240-777-7263

MONTGOMERY COUNTY
DEPARTMENT OF TRANSPORTATION
GAITHERSBURG, MARYLAND
RECOMMENDED FOR APPROVAL

Designed by : DLA

Chief, Transportation Planning and Design Section Chief, Division of Transportation Engineering Date Drawn by : ____DLA

GN-01 TITLE SHEET NEEDWOOD ROAD BIKE PATH/TRAIL MUNCASTER MILL ROAD

RELATED REQUIRED PERMITS To be completed by the consultant and placed on the first sheet of the Sediment Control / Stormwater Management plan set for all projects IT IS THE RESPONSIBILITY OF PERMITTEE/OWNER OF THIS SITE TO OBTAIN ALL REQUIRED PERMITS PRIOR TO ISSUANCE OF THE APPROVED SEDIMENT CONTROL PERMIT

WATERWAYS/WETLAND(S)

Corps of Engineers

DNR Roadside Tree Care

Protection Plan

N.P.D.E.S.

NOTICE OF INTENT

OTHERS (Please List):

MDE Water Quality Certification MDE Dam Safety

WORK RESTRICTION DATES

DATE FILED


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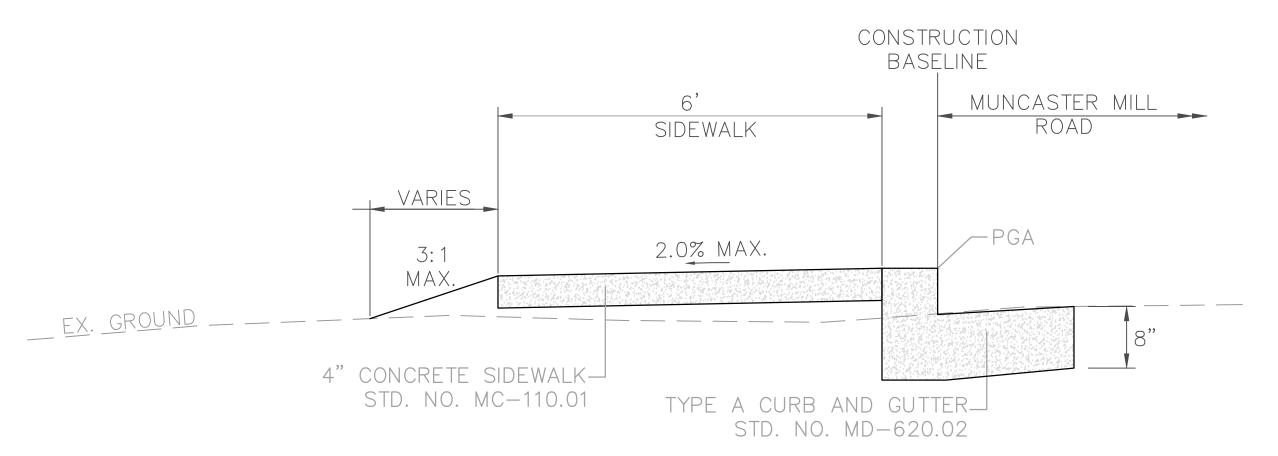
Approval Date

Approval Date

DATE: NOVEMBER 2015 Checked by : SAM Project No. : 501304 SHEET _____ 1 ___ of ____ 9



SIDEWALK SECTION, MUNCASTER MILL ROAD STA. 404+20 TO STA. 407+37

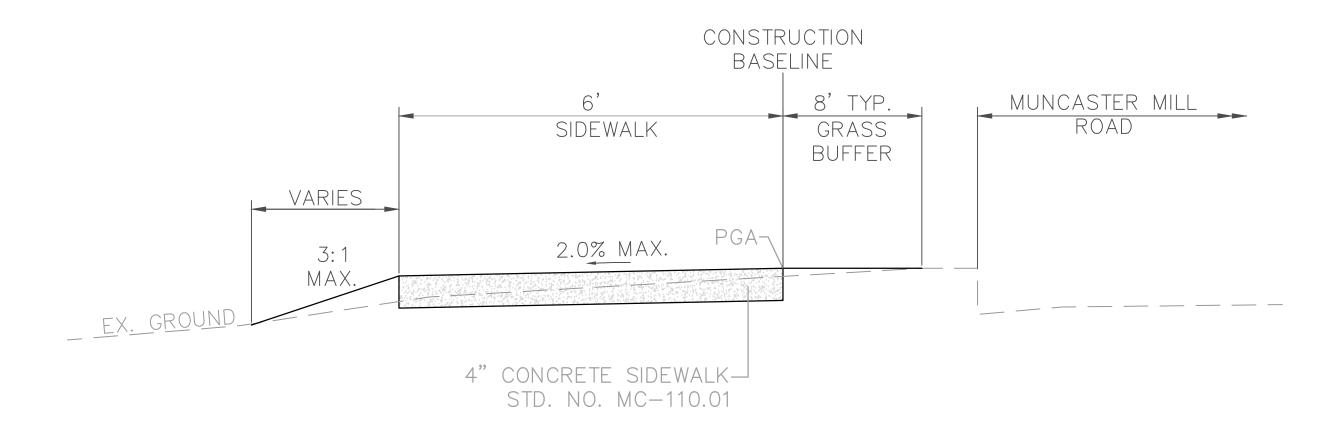

CURBED SIDEWALK SECTION, MUNCASTER MILL ROAD STA. 400+53 TO STA. 404+20 STA. 407+80 TO STA. 408+20

90% FINAL DESIGN
THESE PLANS ARE NOT FOR CONSTRUCTION




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					RECOMMENDED FOR APPROVAL	$\begin{bmatrix} \\ \end{bmatrix}$ B
					Chief, Design Section Date APPROVED	
					Chief, Division of Transportation Engineering Date	SCA
╛	NO.	REVISION	DATE	BY	Designed by: <u>ADS</u> Drawn by: <u>ADS</u> Checked by: <u>JJR</u>	Project

TS-02 TYPICAL SECTION

NEEDWOOD ROAD
BIKE PATH/TRAIL-PHASE II

 SCALE:
 N.T.S.
 DATE:
 OCTOBER 2015

 Project No. :
 501304
 SHEET
 2 of 9

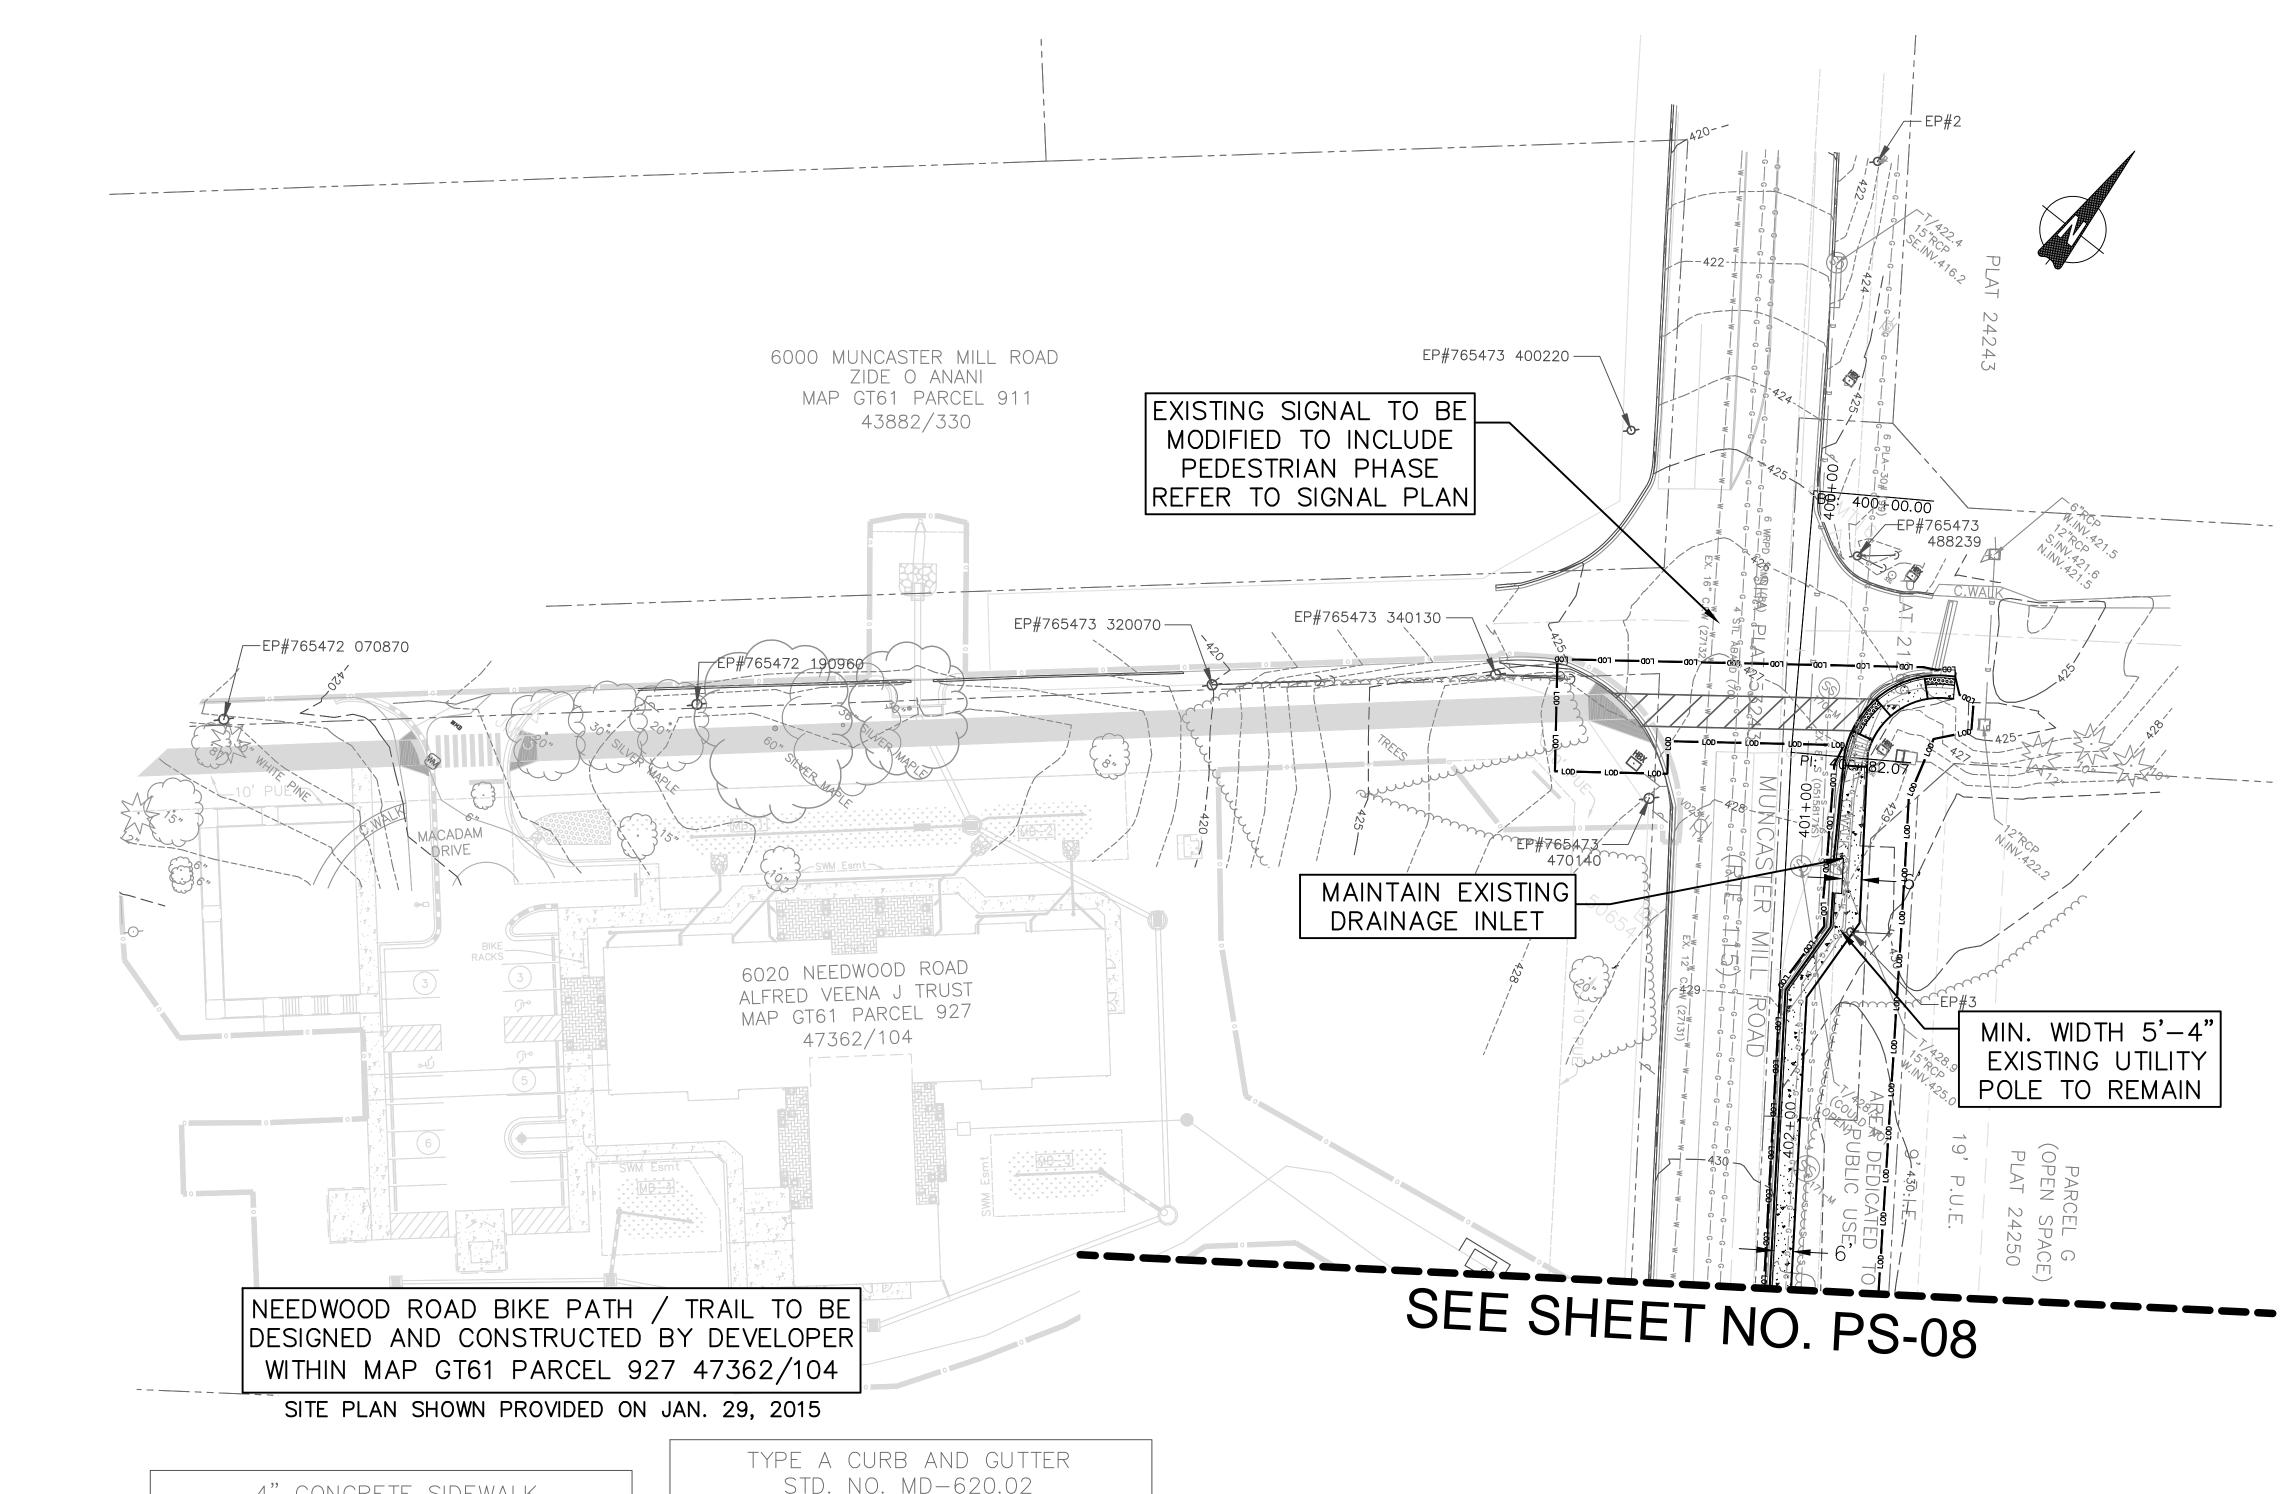

NOTE:

1. TREATMENT A: TREE TO REMAIN.

2. TREATMENT B: REMOVE TREE INCLUDING STUMP.

	LEC	<u>GEND</u>	
LOD LOD	LIMIT OF DISTURBANCE		PROPOSED ASPHALT PATH/TRAIL-IMPERVIOUS
	LIMIT OF GRADING PROPOSED PAVEMENT		PROPOSED PATH/TRAIL- PERVIOUS PAVING
— ra:— ra:— ra:—	MARKINGS TEMPORARY		PROPOSED FULL DEPTH ASPHALT DRIVEWAY
— n — n — n —	CONSTRUCTION EASEMENT PERMANENT EASEMENT		PROPOSED MILL AND OVERLAY
	PROPOSED CONCRETE SIDEWALK		PROPOSED PAVEMENT REMOVAL

4" CONCRETE SIDEWA	ALK
\bigcirc T \wedge \top I \bigcirc \land I	
STATION	SF
400+54.68 TO 402+50.00	1357.35

STATION

400+54.10

400+68.09

* STATION AND OFFSET ARE APPLIED AT THE CENTERLINE OF SIDEWALK RAMP, AT THE ROADWAY EDGE.

TYPE A CURB AND GUTTER STD. NO. MD-620.02			
STATION	LF		
400+53.98 TO 401+14.44	78.27		
401+25.29 TO 402+50.00	128.56		

INSTALL SIDEWALK RAMP AND DETECTABLE WARNING SURFACE STD. NO. MD-655.12 AND MD-655.40* OFFSET 44.30' LT 21.13' LT Engineering A Brighter Future®

90% FINAL DESIGN
THESE PLANS ARE NOT FOR CONSTRUCTION

72 Loveton Circle, Sparks, MD 21152
Telephone: (410) 329-3100; Fax: (410) 472-2200; WEB: WWW.JMT.COM

				MONTGOMERY COUNTY DEPARTMENT OF TRANSPORTATION GAITHERSBURG, MARYLAND	
				RECOMMENDED FOR APPROVAL	1
				Chief, Design Section Date APPROVED	
				Chief, Division of Transportation Engineering Date	
10.	REVISION	DATE	BY	Designed by: ADS Drawn by: ADS Checked by: JJR	

PS-07 PLAN SHEET NEEDWOOD ROAD BIKE PATH/TRAIL-PHASE II DATE: OCTOBER 2015 SCALE: 1"=30'

SHEET <u>3</u> of <u>9</u>

Project No. : <u>501304</u>

DETECTABLE WA	ALK RAMP AND ARNING SURFACE 11 AND MD-655.40*
STATION	OFFSET
405+31.06	21.13' LT
405+73.06	21.13' LT
407+33.09	21.13' LT


* STATION AND OFFSET ARE APPLIED AT THE CENTERLINE OF SIDEWALK RAMP, AT THE ROADWAY EDGE.

DETECTABLE WA	ALK RAMP AND ARNING SURFACE 2 AND MD-655.40*
STATION	OFFSET
408+04.82	25.25' LT
407+98.82	84.07' LT
407+98.01	113.94' LT
407+87.98	136.09' LT

* STATION AND OFFSET ARE APPLIED AT THE CENTERLINE OF SIDEWALK RAMP, AT THE ROADWAY EDGE.

TYPE A CURB AND GUTTER STD. NO. MD-620.02							
STATION LF							
402+50.00 TO 404+30.75 183.4	-4						
405+19.79 TO 405+36.74 24.74	4						
405+67.98 TO 405+84.24 24.5	4						
407+19.22 TO 407+40.81 26.9	1						
407+82.00 TO 408+10.05 84.20	0						
407+83.00 TO 408+12.89 51.7	7						

4" CONCRETE SIDEWALK							
STATION	SF						
402+50.00 TO 405+36.53	1780.25						
405+68.14 TO 407+40.42	1080.26						
407+82.72 TO 408+11.88	469.15						
407+82.98 TO 408+12.89	255.45						

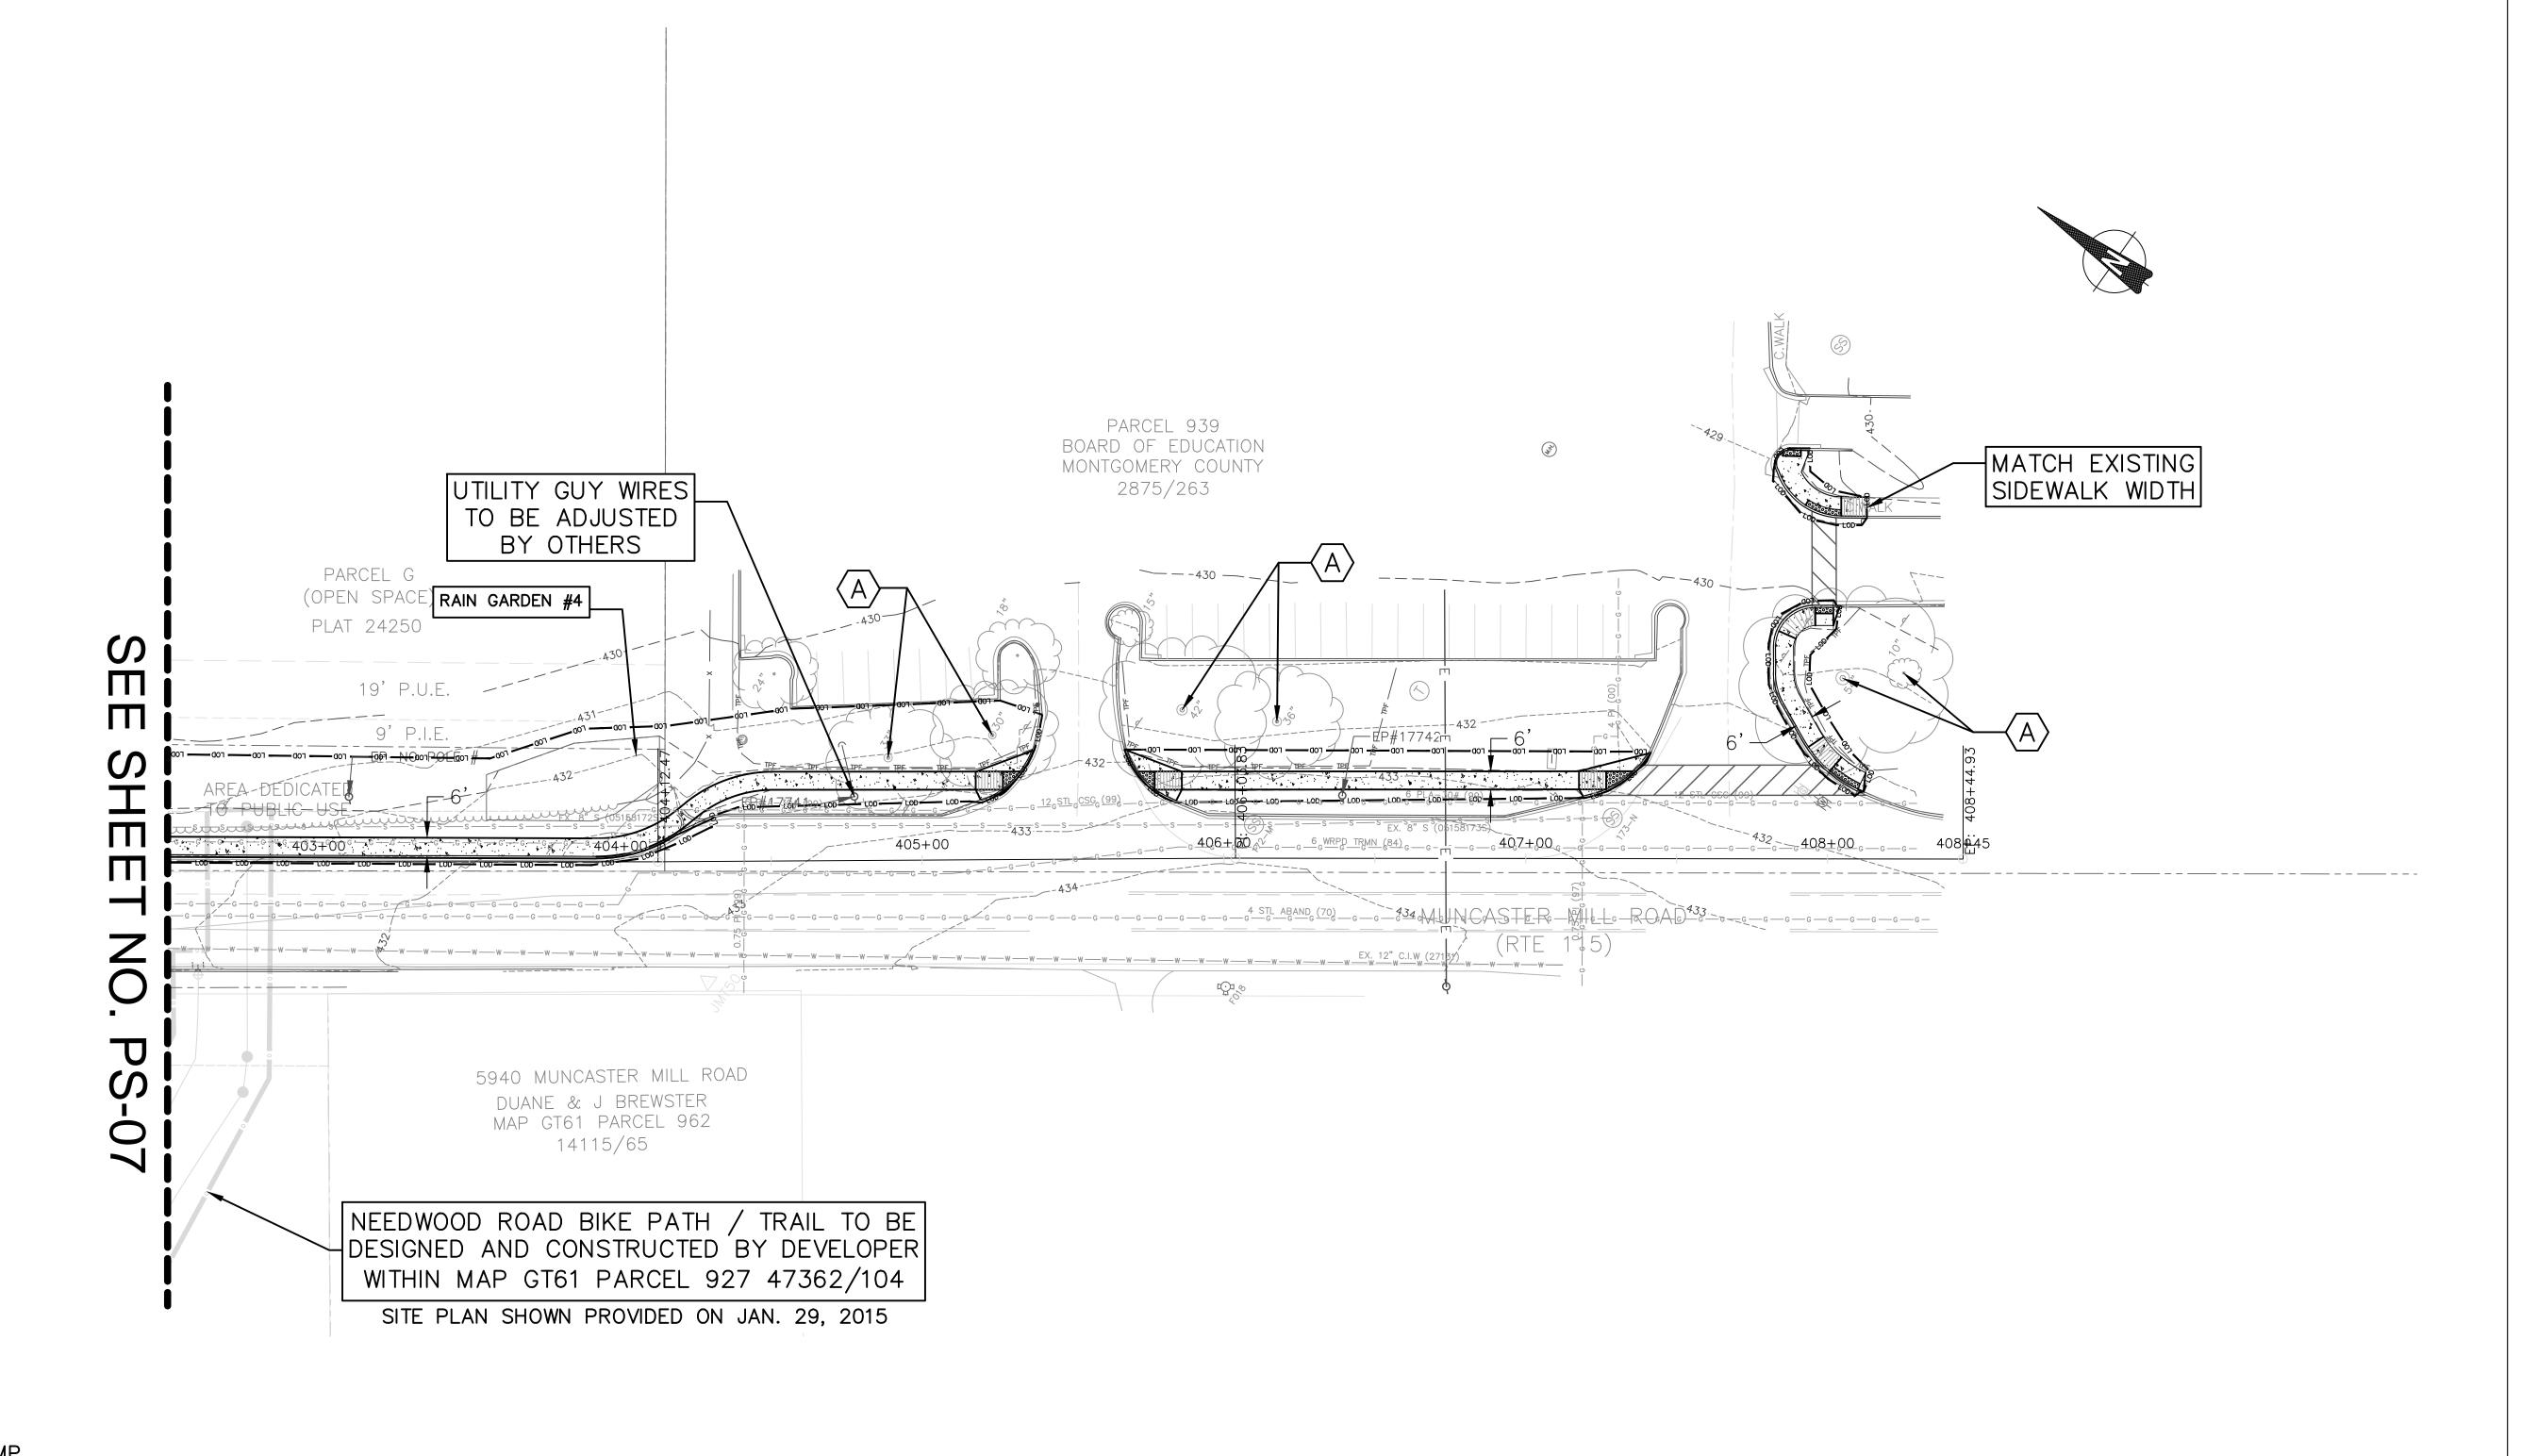


REVISION

NOTE:

1. TREATMENT A: TREE TO REMAIN.

2. TREATMENT B: REMOVE TREE INCLUDING STUMP.

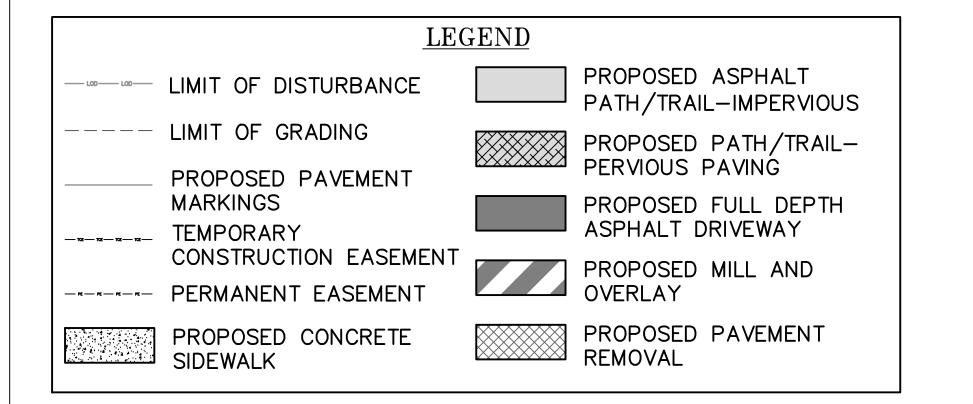

90% FINAL DESIGN THESE PLANS ARE NOT FOR CONSTRUCTION



				MONTGOMERY COUNT DEPARTMENT OF TRANSPOR GAITHERSBURG, MARYLA	PS-C	
				RECOMMENDED FOR APPROVAL		NEE Bike pat
				Chief, Design Section APPROVED	Date	0 30'
				Chief, Division of Transportation Engineering	Date	SCALE: 1"=30'
NO.	REVISION	DATE	BY	Designed by: ADS Drawn by: ADS	Checked by:JJR	Project No. : <u>501304</u>

PS-08 PLAN SHEET NEEDWOOD ROAD BIKE PATH/TRAIL-PHASE II DATE: OCTOBER 2015 SCALE: 1"=30'

SHEET <u>4</u> of <u>9</u>

EROSION AND SEDIMENT CONTROL — GENERAL NOTES

AT-GRADE INLET PROTECTION

BAFFLE BOARDS

CLEAR WATER PIPE

FILTER LOG

MEDIAN INLET PROTECTION

PERIMETER DIKE/SWALE

STANDARD EROSION AND SEDIMENT CONTROL NOTES

- 1. The permittee shall notify the Department of Permitting Services (DPS) forty—eight (48) hours before commencing any land disturbing activity and, unless waived by the Department, shall be required to hold a pre-construction meeting between them or their representative, their engineer and an authorized representative of the Department.
- 2. The permittee must obtain inspection and approval by DPS at the following points:
- A. At the required pre-construction meeting.
- B. Following installation of sediment control measures and prior to any other land disturbing activity.
- C. During the installation of a sediment basin or stormwater management structure at the required inspection points (see Inspection Checklist on plan). Notification prior to commencing construction is mandatory.
- D. Prior to removal or modification of any sediment control structure(s).
- E. Prior to final acceptance.
- 3. The permittee shall construct all erosion and sediment control measures per the approved plan and construction sequence, shall have them inspected and approved by the Department prior to beginning any other land disturbances, shall ensure that all runoff from disturbed areas is directed to the sediment control devices, and shall not remove any erosion or sediment control measure without prior permission from the Department.
- 4. The permittee shall protect all points of construction ingress and egress to prevent the deposition of materials onto traversed public thoroughfare(s). All materials deposited onto public thoroughfare(s) shall be removed immediately.
- 5. The permittee shall inspect periodically and maintain continuously in effective operating condition, all erosion and sediment control measures until such time as they are removed with prior permission from the Department. The permittee is responsible for immediately repairing or replacing any sediment control measures which have been damaged or removed by the permittee or any other person.
- 6. Following initial soil disturbance or re—disturbance, permanent or temporary stabilization must be completed within:
- a) Three (3) calendar days as to the surface of all perimeter dikes, swales, ditches, perimeter slopes and all slopes steeper than 3 horizontal to 1 vertical (3:1); and
- Seven (7) calendar days as to all other disturbed or graded areas on the project site not under active grading.
- All areas disturbed outside of the perimeter sediment control system must be minimized and stabilized immediately. Maintenance must be performed as necessary to ensure continued stabilization.
- 7. The permittee shall apply sod, seed, and anchored straw mulch, or other approved stabilization measures to all disturbed areas within seven (7) calendar days after stripping and grading activities have ceased on that area. Maintenance shall be performed as necessary to ensure continued stabilization. Active construction areas such as borrow or stockpile areas, roadway improvements, and areas within fifty (50) feet of a building under construction may be exempt from this requirement, provided that erosion and sediment control measures are installed and maintained to protect those areas.
- 8. Prior to removal of sediment control measures, the permittee shall stabilize all contributory disturbed areas with required soil amendments and topsoil, using sod or an approved permanent seed mixture and an approved anchored mulch. Wood fiber mulch may only be used in seeding season when the slope does not exceed 10% and grading has been done to promote sheet flow drainage. Areas brought to finished grade during the seeding season shall be permanently stabilized within seven (7) calendar days of establishment. When property is brought to finished grade during the months of November through February, and permanent stabilization is found to be impractical, an approved temporary seed and straw anchored mulch shall be applied to disturbed areas. The final permanent stabilization of such property shall be completed prior to the following April
- 9. The site permit, work, materials, approved SC/SM plans, and test reports shall be available at the site for inspection by duly authorized officials of Montgomery County.
- 10. Surface drainage flows over unstabilized cut and fill slopes shall be controlled by either preventing drainage flows from traversing the slopes or by installing mechanical devices to lower the water down slope without causing erosion. Dikes shall be installed and maintained at the top of cut or fill slopes until the slope and drainage area to it are fully stabilized, at which time they must be removed and final grading done to promote sheet flow drainage. Mechanical devices must be provided at points of concentrated flow where erosion is likely to occur.
- 11. Permanent swales or other points of concentrated water flow shall be stabilized within 3 calendar days of establishment with sod or seed with an approved erosion control matting or by other approved stabilization measures.
- 12. Sediment control devices shall be removed, with permission of the Department, within thirty (30) calendar days following establishment of permanent stabilization in all contributory drainage areas. Stormwater management structures used temporarily for sediment control shall be converted to the permanent configuration within this time period as well.
- 13. No permanent cut or fill slope with a gradient steeper than 3:1 will be permitted in lawn maintenance areas or on residential lots. A slope gradient of up to 2:1 will be permitted in non— maintenance areas provided that those areas are indicated on the erosion and sediment control plan with a low—maintenance ground cover specified for permanent stabilization. Slope gradient steeper than 2:1 will not be permitted with vegetative stabilization.
- 14. The permittee shall install a splashblock at the bottom of each downspout unless the downspout is connected by a drain line to an acceptable outlet.
- 15. For finished grading, the permittee shall provide adequate gradients so as to prevent water from standing on the surface of lawns more than twenty—four (24) hours after the end of a rainfall, except in designated drainage courses and swale flow areas, which may drain as long as forty—eight (48) hours after the end of a rainfall.
- 16. Sediment traps or basins are not permitted within 20 feet of a building which is existing or under construction. No building may be constructed within 20 feet of a sediment
- 17. All inlets in non-sump areas shall have asphalt berms installed at the time of base paving establishment.
- 18. The sediment control inspector has the option of requiring additional sediment control measures, as deemed necessary.
- 19. All trap elevations are relative to the outlet elevation, which must be on existing undisturbed ground.
- 20. Vegetative stabilization shall be performed in accordance with the Standards and Specifications for Soil Erosion and Sediment Control.
- 21. Sediment trap(s)/basin(s) shall be cleaned out and restored to the original dimensions when sediment has accumulated to the point of one—half (1/2) the wet storage depth of the trap/basin (1/4 the wet storage depth for ST-III) or when required by the sediment control inspector.
- 22. Sediment removed from traps/basins shall be placed and stabilized in approved areas, but not within a floodplain.
- 23. All sediment basins and traps must be surrounded with a welded wire safety fence. The fence must be at least 42 inches high, have posts spaced no farther apart than 8 feet, have mesh openings no greater the two inches in width and four inches in height, with a minimum of 14 gauge wire. Safety fence must be maintained in good condition at all times.
- 24. No excavation in the areas of existing utilities is permitted unless their location has been determined. Call "Miss Utility" at 1-800-257-7777, 48 hours prior to the start of
- 25. Off—site spoil or borrow areas must have prior approval by DPS.
- 26. Sediment trap/basin dewatering for cleanout or repair may only be done with the DPS inspector's permission. The inspector must approve the dewatering method for each application. The following methods may be considered:
- A. Pump discharge may be directed to another on—site sediment trap or basin, provided it is of sufficient volume and the pump intake is floated to prevent agitation or suction of deposited sediments; or
- B. the pump intake may utilize a Removable Pumping Station and must discharge into an undisturbed area through a non-erosive outlet; or
- C. the pump intake may be floated and discharge into a Dirt Bag (12 oz. non—woven fabric), or approved equivalent, located in an undisturbed buffer area. Remember: Dewatering operation and method <u>must</u> have prior approval by the DPS inspector.
- 27. The permittee must notify the Department of all utility construction activities within the permitted limits of disturbance prior to the commencement of those activities.
- 28. Topsoil must be applied to all pervious areas within the limits of disturbance prior to permanent stabilization in accordance with MDE "Standards and Specifications for Soil Preparation, Topsoiling, and Soil Amendments".

STANDARD SYMBOLS REMOVABLE PUMPING STATION

RIPRAP INFLOW PROTECTION

ROCK OUTLET PROTECTION III

STANDARD INLET PROTECTION

TEMPORARY ASPHALT BERM

TEMP. SOIL STABILIZATION MATTING-TYPE A

BENCHIN BENCHING RIPRAP OUTLET SEDIMENT TRAP ST III CATCH BASIN INSERT **ROCK OUTLET PROTECTION 1**

CWD - 12 CLEAR WATER DIVERSION PIPE ROCK OUTLET PROTECTION II DESIGNATION CWD-12 REFERS TO 12 INCH CLEAR WATER DIVERSION

COIP COMBINATION INLET PROTECTION SILT FENCE

CONCRETE WASHOUT STRUCTURE SILT FENCE ON PAVEMENT [4] CIP CURB INLET PROTECTION SOD

DIVERSION FENCE STABILIZED CONSTRUCTION ENTRANCE EARTH DIKE

EMERGENCY SPILLWAY ES STOCKPILE AREA FILTER BAG STONE CHECK DAM

PLACE DESIGNATION (A-1, B-2, etc.)
ON FLOW CHANNEL SIDE OF DIKE.

I--- FB- A---I FILTER BERM ST-II STONE/RIPRAP OUTLET SEDIMENT TRAP ST II I---FB-B---I

SUBSURFACE DRAINS GABION INFLOW PROTECTION SUMP PIT

GABION INLET PROTECTION SUPER SILT FENCE HORIZONTAL DRAW-DOWN DEVICE TEMPORARY ACCESS BRIDGE

TEMPORARY ACCESS CULVERT LIMIT OF DISTURBANCE

TEMPORARY BARRIER DIVERSION MEDIAN SUMP INLET PROTECTION MSIP

MOUNTABLE BERM TEMPORARY GABION OUTLET STRUCTURE

PERM. SOIL STABILIZATION MATTING-TYPE B TEMP. SOIL STABILIZATION MATTING-TYPE E

PERM. SOIL STABILIZATION MATTING-TYPE C TEMP. SOIL STABILIZATION MATTING-TYPE D TEMPORARY STONE OUTLET STRUCTURE PIPE OUTLET SEDIMENT TRAP ST I

TEMPORARY SWALE PIPE SLOPE DRAIN DESIGNATION PSD-12 REFERS T 12 INCH PIPE SLOPE DRAIN.

WASH RACK OPTION PLUNGE POOL PORTABLE SEDIMENT TANK CHESAPEAKE BAY CRITICAL AREA

TREE PROTECTION FENCE DRAINAGE BOUNDARY

WETLAND EXISTING CONTOURS

WETLAND BUFFER PROPOSED CONTOURS 100-YEAR FLOODPLAIN 3. Types of storm drain structures refer to the 'Design Standards' of Montgomery County Department of Transportation, unless otherwise noted. 4. Information concerning underground utilities was obtained from available records, The contractor must determine the exact location and elevations of the lines by digging test pits by hand at all utility crossings well in advance of

STANDARD NOTES

1. The contractor will immediately inform the county of any discrepancies found between the project plans and

trenchina. If clearances are less than shown on this plan or six inches, whichever is less, the contractor shall 5. Repairs to utilities or property damaged as a result of the contractor's negligence or method of operation must

be made at the contractor's expense before proceeding with construction. 6. Call "Miss Utility" at 1-800-257-7777 fourty-eight (48) hours prior to beginning excavation to determine the exact location of existing utilities.

7. Clearing to be limited to the "limit of disturbance" as shown on the plans. 8. All grading shall be done in such a manner as to provide positive drainage.

For construction, all horizontal control shall be NAD 83/91 and vertical control NAVD 88.

9. Disturbed areas adjacent to established lawns shall be sodded. Other disturbed areas shall be seeded and mulched.

10. The contractor shall obtain a roadside tree permit for any maintenance, treatment, planting, removal or root cutting on trees within the public right-of-way before starting a job. Permit requirements may be obtained from the Department of Natural Resources — Maryland Forest, Park and Wildlife service whose telephone number is (301)

11. Contact the Washington Suburban Sanitary Commission system maintenance engineer before excavating beneath or in the vicinity of existing water or sewer lines. Backfill to be done under the supervision of W.S.S.C. call

12. Contact Washington gas dispatch officer at (703) 750-4831 before excavating beneath or in the vicinity of existing gas main and service laterals. 13. Prior to vegetative stabilization, all disturbed areas must be topsoiled per the Montgomery County "Standards and

Specifications for topsoil". 14. Prior to clearing trees, installing sediment control measures, or grading, a preconstruction meeting must be conducted on—site with the Montgomery County Department of Permitting Services (MCDPS) sediment control inspector (240) 777—6210 (48 hours notice) and the MNCPPC, Planning Department, Plans Enforcement inspector (301)

495—4571 (48 hoùrs notice), the Owners representative, and the site Engineer. 15. The limits of disturbance shall be field marked prior to clearing of trees, installation of sediment control measures, construction, or other land disturbing activities. 16. The permittee must obtain written approval from the MNCPPC inspector, certifying that the limits of disturbance

and tree protection measures are correctly marked and installed prior to commencing any clearing. 17. Clear and grade for installation of sediment control devices. 18. Install sediment control devices. Traps and basins shall be constructed prior to construction of any earth dikes

that convey drainage to a trap and/or basin. 19. Once the sediment control devices are installed, the permittee must obtain written approval from the MCDPS inspector before proceeding with any additional clearing, grubbing or grading.

NOTE 1: All sequences should call for the permittee to obtain written approval from MCDPS inspector, prior to the removal of any sediment control devices.

NOTE 2: Any site that has a proposed storm drain diversion should have its Sequence of Construction state

The construction of the diversion in the storm drain construction step; and 2) Once the drainage area is stabilized, the storm drain system must be flushed, and temporary pipes removed, and any permanent pipes unblocked or constructed.

OWNER/DEVELOPER'S CERTIFICATION SITE INFORMATION DISTURBED AREA CUT FILL (LOD) I/We hereby certify that all clearing, grading, construction, and or development will be done pursuant to this plan and that any responsible (CY) (CY) personnel involved in the construction project will have a Certificate of PHASE 1: 2.785 ac Attendance at Department of Natural Resources approved training program for the control of sediment and erosion before beginning the project. PHASE 2: 3.759 ac 2680 235 SPA: 0.447 ac TOTAL: 6.991 ac

Registration Number

Printed Name and Title

Printed Name

contract specifications.

ST-III

ROP1

ROPIII

⊢—SF——

——SF0P——

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— SSD — →

⊠SP

⊢—SSF—

TBD

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PLACE DESIGNATION (A-1, B-2, etc.) ON FLOW CHANNEL SIDE OF SWALE.

WR

— TPF —

Chief, Design Section

APPROVED

DESIGN CERTIFICATION

I hereby certify that this plan has been prepared in accordance with the "2011 Maryland Standards and Specifications for Soil Erosion and Sediment Control," Montgomery County Department of Permitting Services Executive Regulations 5-90, 7-02AM and 36-90, and Montgomery County Department of Public Works and Transportation "Storm Drain Design Criteria" dated August 1988.

			_		
Design	Engineer	Signature		Date	

P.E. CERTIFICATION

I HEREBY CERTIFY THAT THESE DOCUMENTS WERE PREPARED OR APPROVED BY ME, AND THAT I AM A DULY LICENSED PROFESSIONAL ENGINEER UNDER THE LAWS OF THE STATE OF MARYLANDLICENSE NO. 28377 , EXPIRATION DATE: 12-31-16

MONTGOMER PERMITTING				NOTE: MCDPS APPI NEGATE THE MCDPS ACCE	NEED FOR A
Stormwater Ma	nagement:	Sediment Cont Requirer	ments:	Administrative	Requirement
		WRC Reviewed	5/26/15 Date	Reviewed	Date
Reviewed	Date	Approved	Date		
Approved	Date				
SM FILE	#			MCDPS APPROVAL OF THIS PLAN THE DATE OF APPROVAL IF THE	

DPS approval of a sediment control or stormwater management plan is for demonstrated compliance with minimum environmental runoff treatment standards and does not create or imply any right to divert or concentrate runoff orto any adjacent property without that property owner's permission. It does not relieve th design engineer or other responsible person of professional liability or ethical responsibility for the adequacy o the drainage design as it affects uphill or downhill properties.



MONTGOMERY COUNTY DEPARTMENT OF TRANSPORTATION GAITHERSBURG, MARYLAND RECOMMENDED FOR APPROVAL


EROSION AND SEDIMENT CONTROL SC-01 NOTES SHEET NEEDWOOD ROAD BIKE PATH/TRAIL-PHASE II


SCALE: AS SHOWN Date Chief, Division of Transportation Engineering

Date

DATE: SEPTEMBER 2015

Designed by: DLA Drawn by: FGY Checked by: SAM Project No. : <u>501304</u> SHEET <u>5</u> of <u>9</u> REVISION

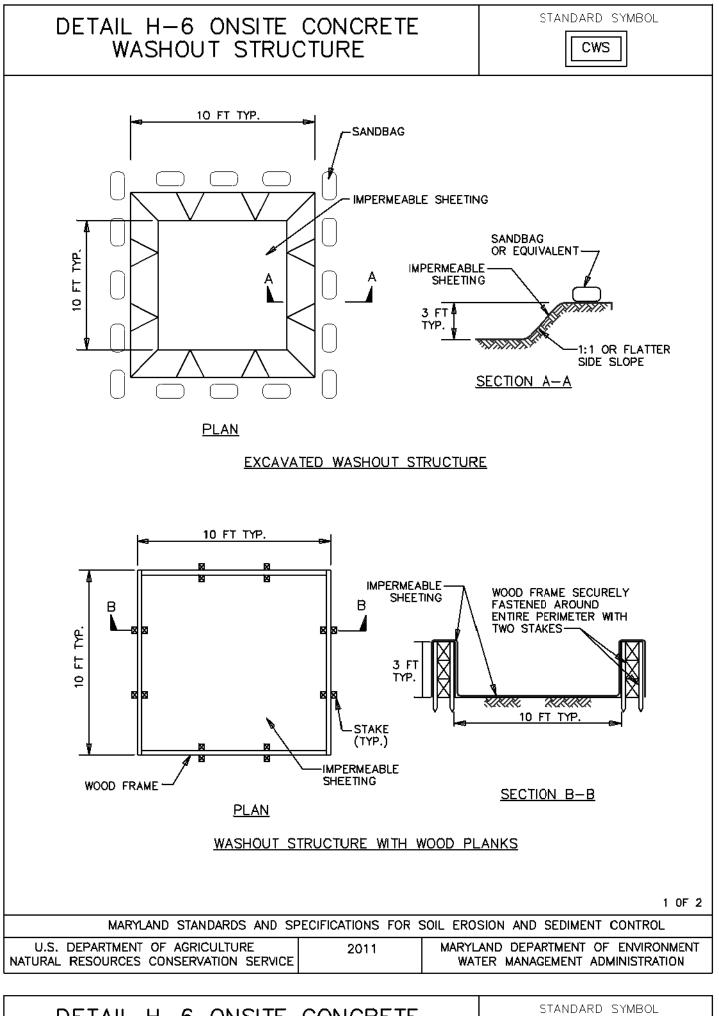

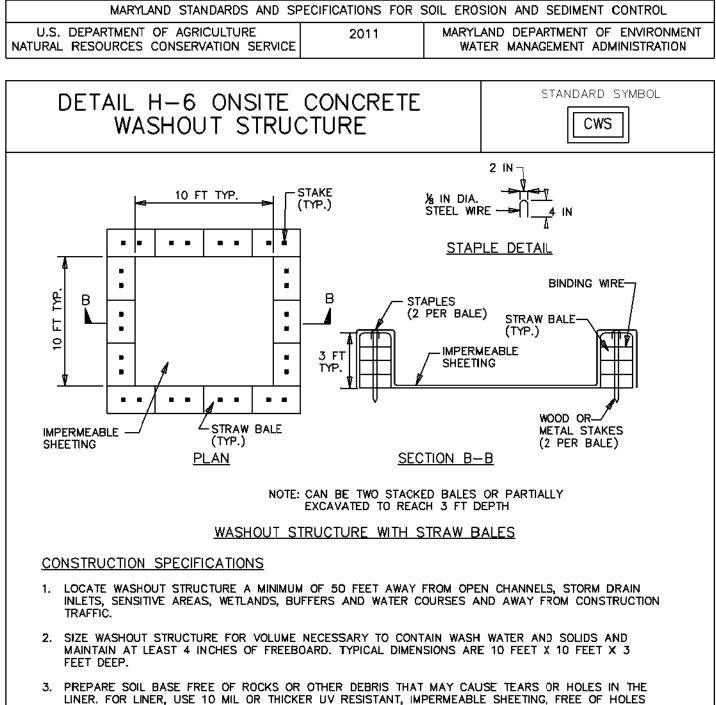

AND TEARS OR OTHER DEFECTS THAT COMPROMISE IMPERMEABILITY OF THE MATERIAL.

5. KEEP CONCRETE WASHOUT STRUCTURE WATER TIGHT. REPLACE IMPERMEABLE LINER IF DAMAGED (E.G.,

LIQUIDS THAT HAVE NOT EVAPORATED AND DISPOSE OF IN AN APPROVED MANNER, PRIOR TO

HARDENED SOLIDS, WHOLE OR BROKEN UP, FOR DISPOSAL OR RECYCLING. MAINTAIN RUNOFF

DIVERSION AROUND EXCAVATED WASHOUT STRUCTURE UNTIL STRUCTURE IS REMOVED.

RIPPED OR PUNCTURED). EMPTY OR REPLACE WASHOUT STRUCTURE THAT IS 75 PERCENT FULL, AND

FORECASTED RAINSTORMS, REMOVE LIQUIDS OR COVER STRUCTURE TO PREVENT OVERFLOWS. REMOVE


DISPOSE OF ACCUMULATED MATERIAL PROPERLY. DO NOT REUSE PLASTIC LINER. WET-VACUUM STORED

MARYLAND STANDARDS AND SPECIFICATIONS FOR SOIL EROSION AND SEDIMENT CONTROL


4. PROVIDE A SIGN FOR THE WASHOUT IN CLOSE PROXIMITY TO THE FACILITY

U.S. DEPARTMENT OF AGRICULTURE

NATURAL RESOURCES CONSERVATION SERVICE

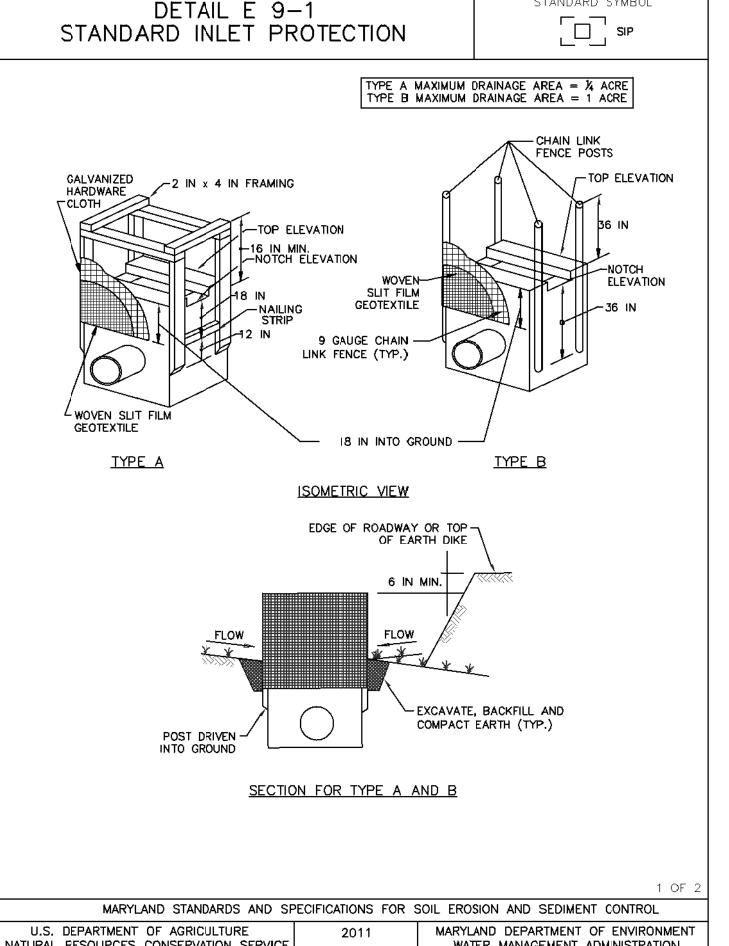

STANDARD SYMBOL

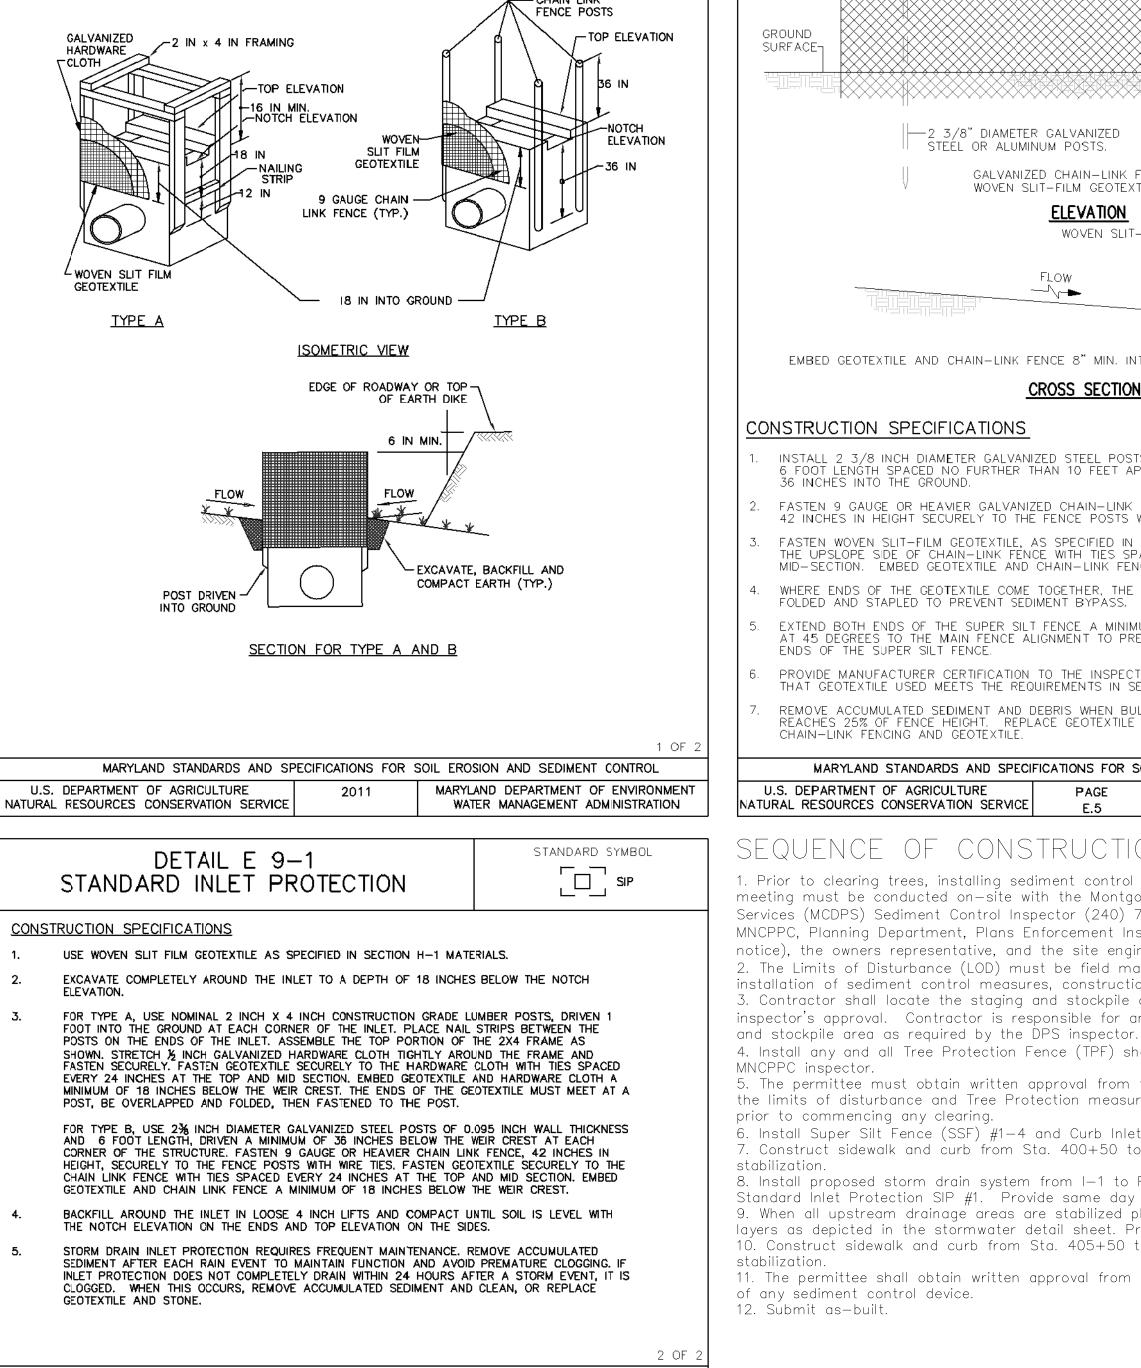

MARYLAND STANDARDS AND SPECIFICATIONS FOR SOIL EROSION AND SEDIMENT CONTROL

MARYLAND DEPARTMENT OF ENVIRONMENT

WATER MANAGEMENT ADMINISTRATION


U.S. DEPARTMENT OF AGRICULTURE

2 OF 2

MARYLAND DEPARTMENT OF ENVIRONMENT

WATER MANAGEMENT ADMINISTRATION

NATURAL RESOURCES CONSERVATION SERVICE

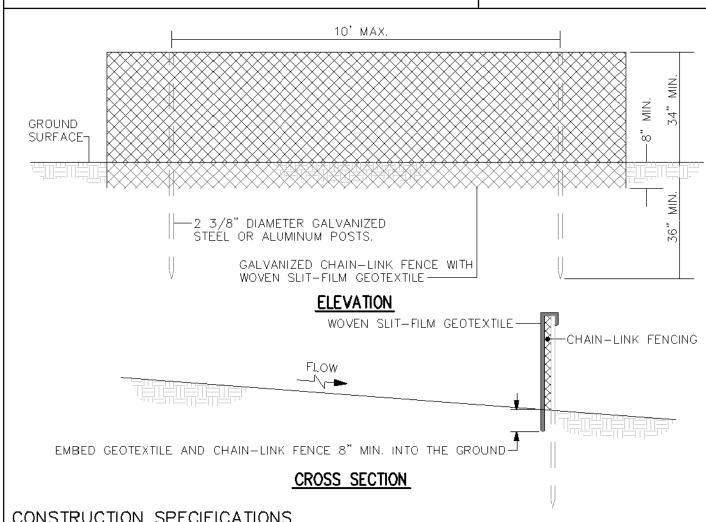

⊢ SSF — I

DETAIL E-3 SUPER SILT FENCE

CONSTRUCTION SPECIFICATIONS

- INSTALL 2 3/8 INCH DIAMETER GALVANIZED STEEL POSTS OF 0.095 INCH WALL THICKNESS AND 6 FOOT LENGTH SPACED NO FURTHER THAN 10 FEET APART. DRIVE THE POSTS A MINIMUM OF
- FASTEN 9 GAUGE OR HEAVIER GALVANIZED CHAIN-LINK FENCE (2 3/8 INCH MAXIMUM OPENING) 42 INCHES IN HEIGHT SECURELY TO THE FENCE POSTS WITH WIRE TIES OR HUG RINGS.
- FASTEN WOVEN SLIT—FILM GEOTEXTILE, AS SPECIFIED IN SECTION H—1 MATERIALS, SECURELY TO THE UPSLOPE SIDE OF CHAIN—LINK FENCE WITH TIES SPACED EVERY 24 INCHES AT THE TOP AND MID—SECTION. EMBED GEOTEXTILE AND CHAIN—LINK FENCE A MINIMUM OF 8 INCHES INTO THE GROUND.
- WHERE ENDS OF THE GEOTEXTILE COME TOGETHER, THE ENDS SHALL BE OVERLAPPED BY 6 INCHES, FOLDED AND STAPLED TO PREVENT SEDIMENT BYPASS.
- EXTEND BOTH ENDS OF THE SUPER SILT FENCE A MINIMUM OF FIVE HORIZONTAL FEET UPSLOPE AT 45 DEGREES TO THE MAIN FENCE ALIGNMENT TO PREVENT RUNOFF FROM GOING AROUND THE ENDS OF THE SUPER SILT FENCE.
- PROVIDE MANUFACTURER CERTIFICATION TO THE INSPECTION/ENFORCEMENT AUTHORITY SHOWING THAT GEOTEXTILE USED MEETS THE REQUIREMENTS IN SECTIONS H-1 MATERIALS.
- REMOVE ACCUMULATED SEDIMENT AND DEBRIS WHEN BULGES DEVELOP IN FENCE OR WHEN SEDIMENT REACHES 25% OF FENCE HEIGHT. REPLACE GEOTEXTILE IF TORN. IF UNDERMINING OCCURS, REINSTALL CHAIN—LINK FENCING AND GEOTEXTILE.

MARYLAND STANDARDS AND SPECIFICATIONS FOR SOIL EROSION AND SEDIMENT CONTROL U.S. DEPARTMENT OF AGRICULTURE WATER MANAGEMENT ADMINISTRATION NATURAL RESOURCES CONSERVATION SERVICE

SEQUENCE OF CONSTRUCTION

1. Prior to clearing trees, installing sediment control measures, or grading, a pre-application meeting must be conducted on—site with the Montgomery County Department of Permitting Services (MCDPS) Sediment Control Inspector (240) 777—0210 (48 hours notice) and the MNCPPC, Planning Department, Plans Enforcement Inspector (301) 495-4571 (48 hours notice), the owners representative, and the site engineer.

2. The Limits of Disturbance (LOD) must be field marked prior to clearing of trees, installation of sediment control measures, construction, or other land disturbing activities. 3. Contractor shall locate the staging and stockpile area within the LOD upon the DPS inspector's approval. Contractor is responsible for any additional E&S controls for staging


4. Install any and all Tree Protection Fence (TPF) shown on the plans or as directed by the MNCPPC inspector. 5. The permittee must obtain written approval from the MNCPPC inspector certifying that

the limits of disturbance and Tree Protection measures are correctly marked and installed prior to commencing any clearing.

6. Install Super Silt Fence (SSF) #1-4 and Curb Inlet Protection (CIP) #1-2. 7. Construct sidewalk and curb from Sta. 400+50 to Sta. 405+50. Provide same day

8. Install proposed storm drain system from I-1 to FC-1 and Open Back Inlet. Install Standard Inlet Protection SIP #1. Provide same day stabilization. 9. When all upstream drainage areas are stabilized place Bio—Swale and Rain Garden media layers as depicted in the stormwater detail sheet. Provide same day stabilization. 10. Construct sidewalk and curb from Sta. 405+50 to Sta. 408+25. Provide same day

11. The permittee shall obtain written approval from MCDPS inspector, prior to the removal of any sediment control device. 12. Submit as—built.

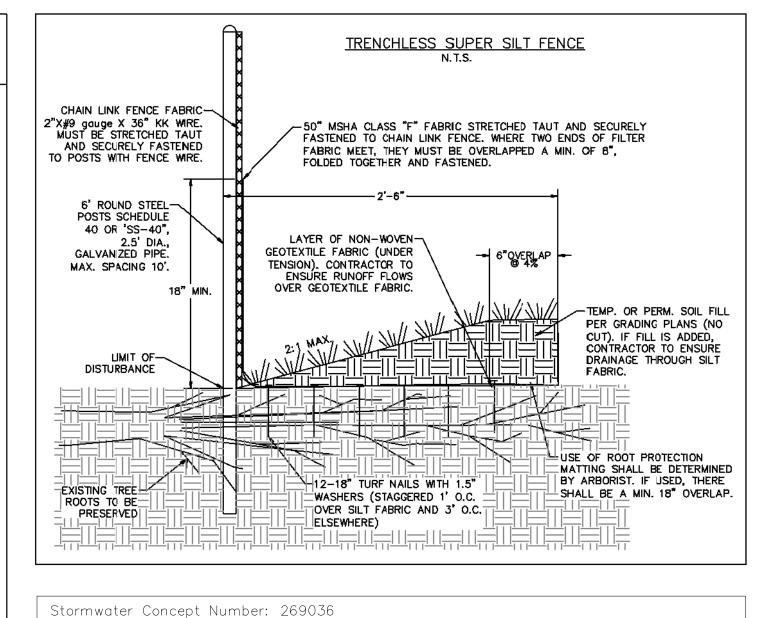

| Project Name/Subdivision: Needwood Road Bike Path/Trail Property Size/Area: 0.447 Acres Property Address/Location: <u>5900 Muncaster Mill Road</u> <u>Derwood/MD</u> <u>20855</u> | Owner/Applicant Information: Name: <u>Dept. of Transportation — Div. of Transportation Eng.</u> Bruce Johnston Mailing Address: 100 Edison Park Drive, 4th Floor City: <u>Gaithersburg</u> State: <u>MD</u> Zip: <u>20878</u> Phone: <u>240-777-7236</u> Engineering Information: Name: Johnson, Mirmiran & Thompson David Adams Mailing Address: <u>72 Loveton Circle</u> City: <u>Sparks</u> State: <u>MD</u> Zip: <u>21152</u> Phone: <u>410-329-3100</u> Type of Application: SPA Water Quality Inventory Type of Submittal: New Stormwater Concept Number: _____ Preliminary Plan # (if applicable): <u>N/A</u> Watershed: <u>Washington Metro Area</u> Lot(s): <u>Various</u> Block(s): N/A Parcel(s): <u>Various</u> Subdivision: N/A

-No dwelling units proposed.

Municipality: <u>N/A</u>

Overall Impervious Area: 0.127 acres Impervious Area Outside Sensitive Areas: 0.127 acres

Environmental Sensitive Areas Disturbed: 0.000 acres, 0.00% Environmental Sensitive Areas Preserved: 0.000 acres, 0.00% Environmental Sensitive Areas Total: 0.000 acres, 0.00%

MCDPS APPROVED FOR: Stormwater Management: Approved Date SM FILE # Sediment Control Technical Requirements: 5/26/15 Reviewed Date Approved Date Administrative Requirements: Reviewed Date SEDIMENT CONTROL PERMIT

MCDPS APPROVAL OF THIS PLAN WILL EXPIRE TWO YEARS FROM THE DATE OF APPROVAL IF THE PROJECT HAS NOT STARTED. THIS APPROVAL DOES NOT NEGATE THE NEED FOR A <u>MCDPS ACCESS PERMIT.</u>

DPS approval of a sediment control or stormwater management plan is for demonstrated compliance with minimum environmental runoff treatment standards and does not create or imply any right to divert or concentrate runoff onto any adjacent property without that property owner's permission. It does not relieve the design engineer or other responsible person of professional liability or ethical responsibility for the adequacy of the drainage design as if affects uphill or downhill properties.



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NO.	REVISION	DATE	BY	


MONTGOMERY COUNTY DEPARTMENT OF TRANSPORTATION GAITHERSBURG, MARYLAND RECOMMENDED FOR APPROVAL Date Chief, Design Section APPROVED Date Chief, Division of Transportation Engineering


Designed by: DLA Drawn by: FGY Checked by: SAM


EROSION AND SEDIMENT CONTROL SC-03 DETAIL SHEET NEEDWOOD ROAD BIKE PATH/TRAIL-PHASE II

SCALE: AS SHOWN

DATE: SEPTEMBER 2015 Project No. : <u>501304</u> SHEET <u>6</u> of <u>9</u>

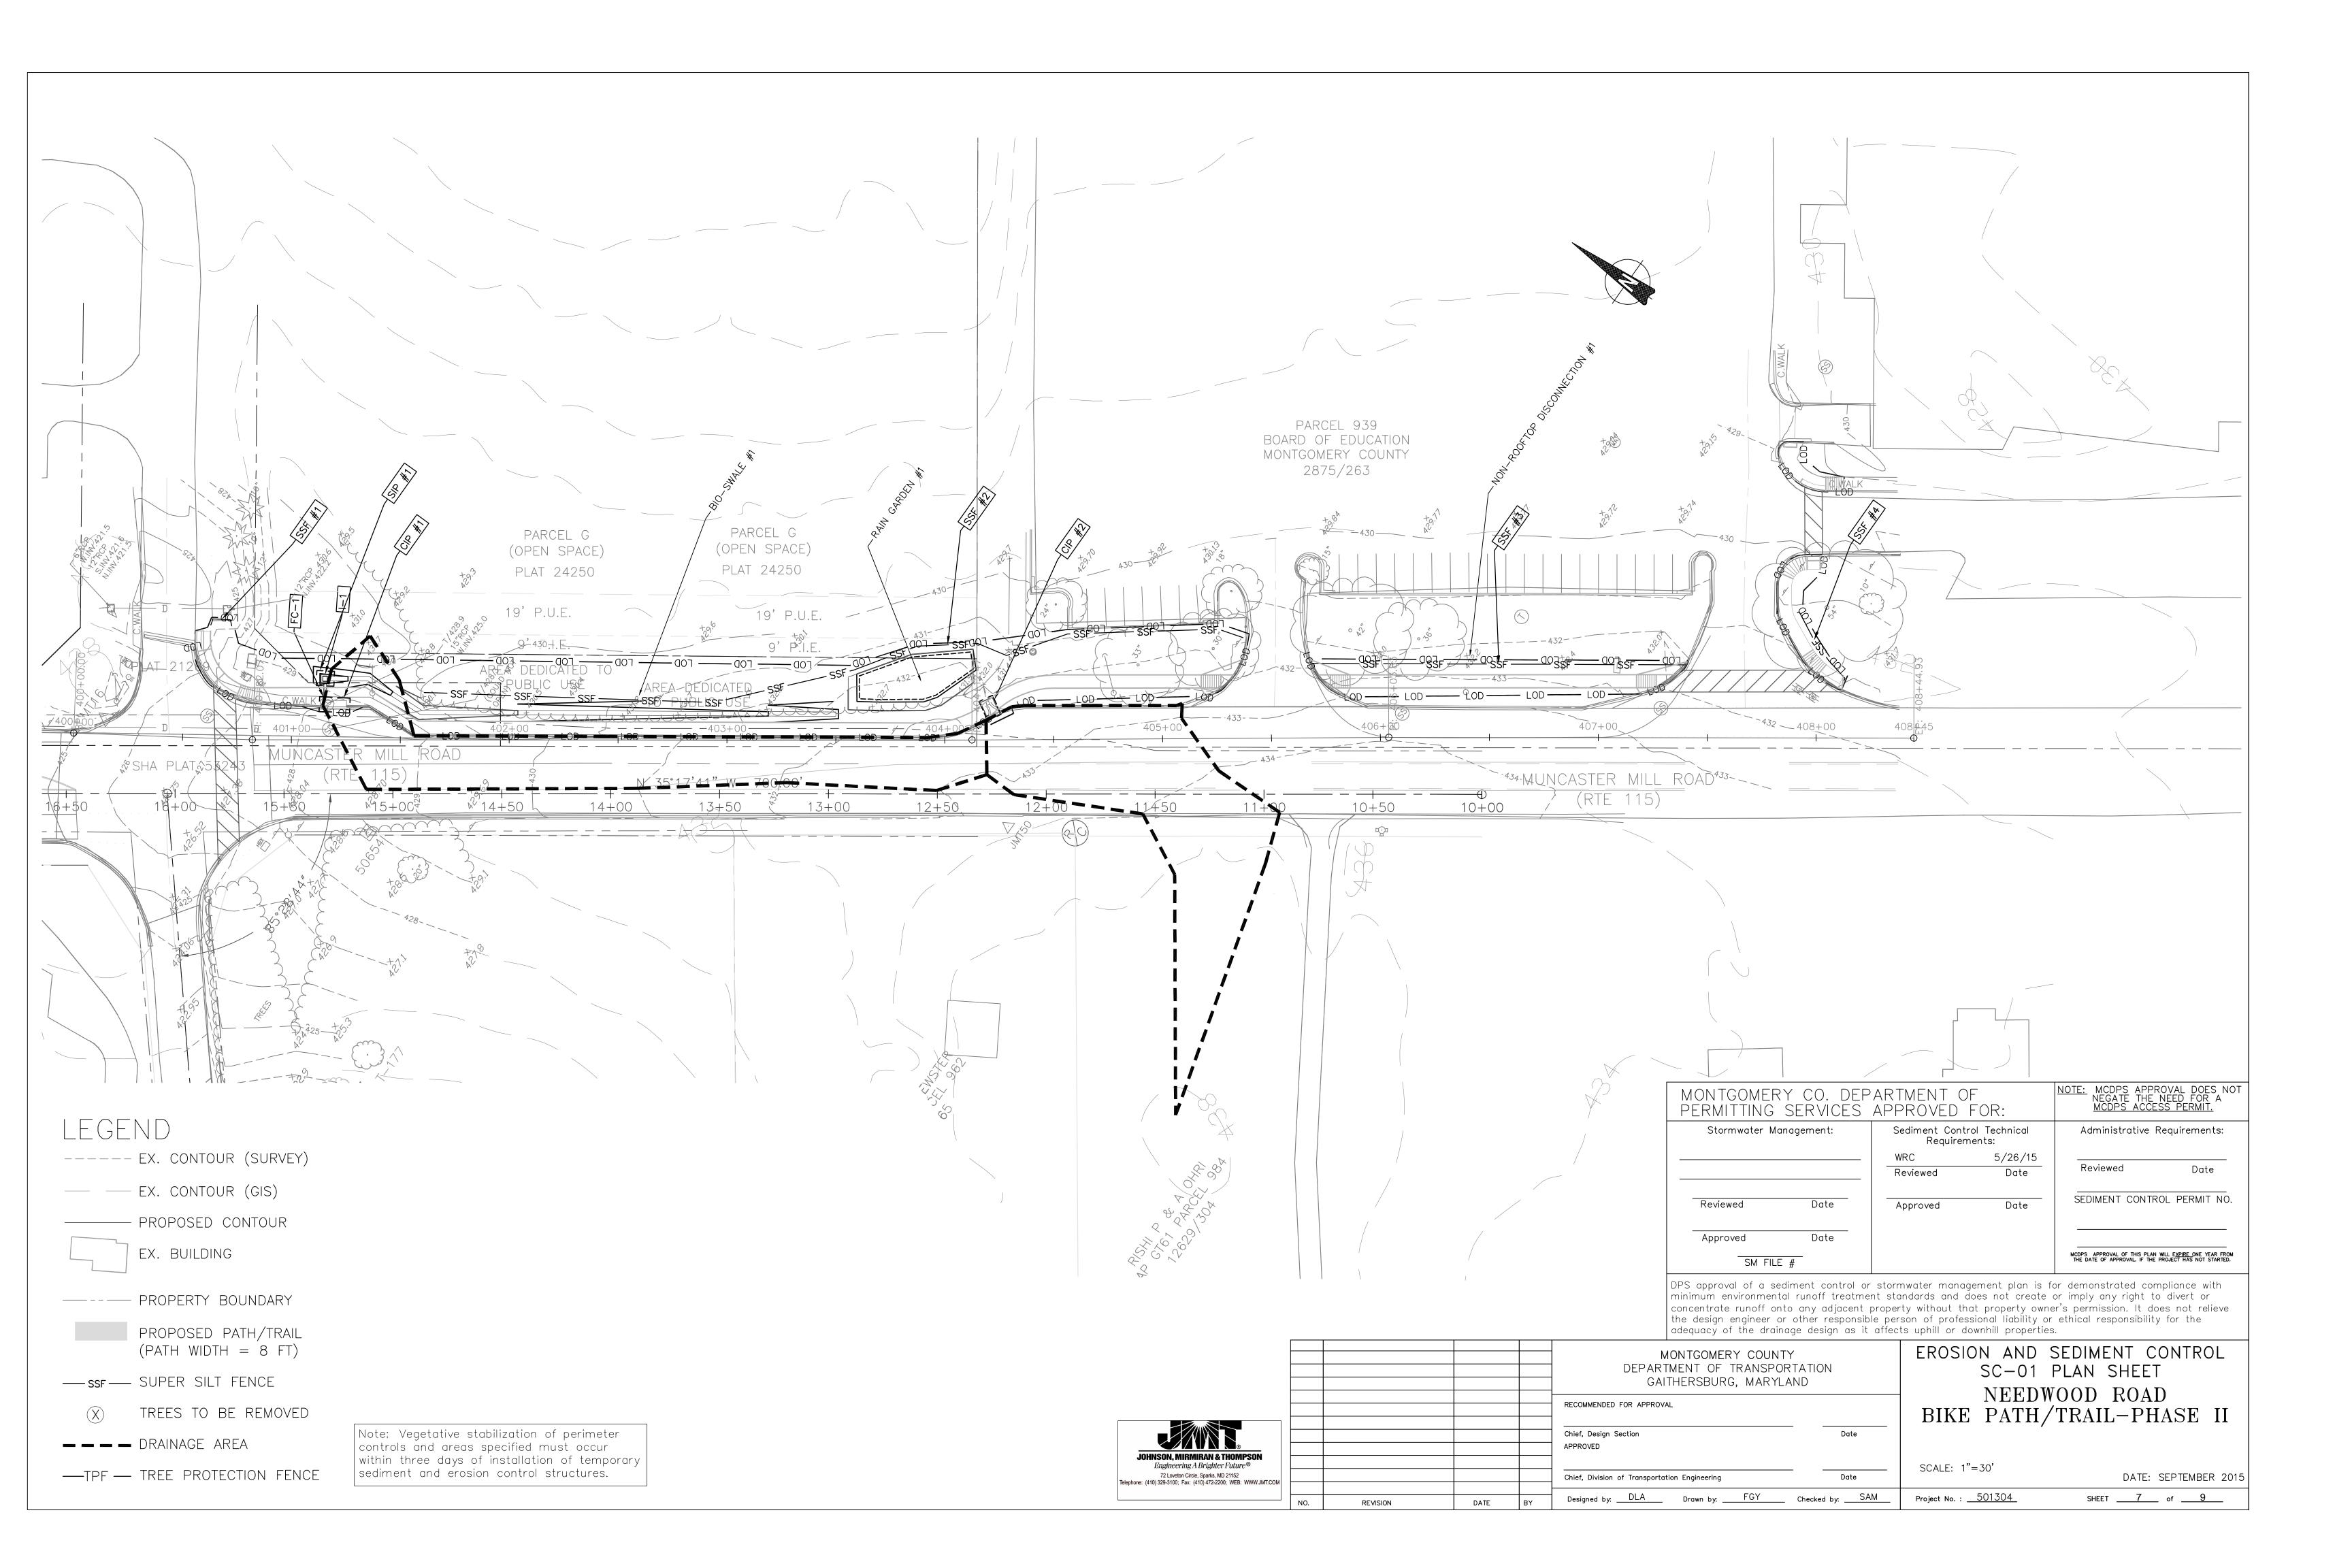

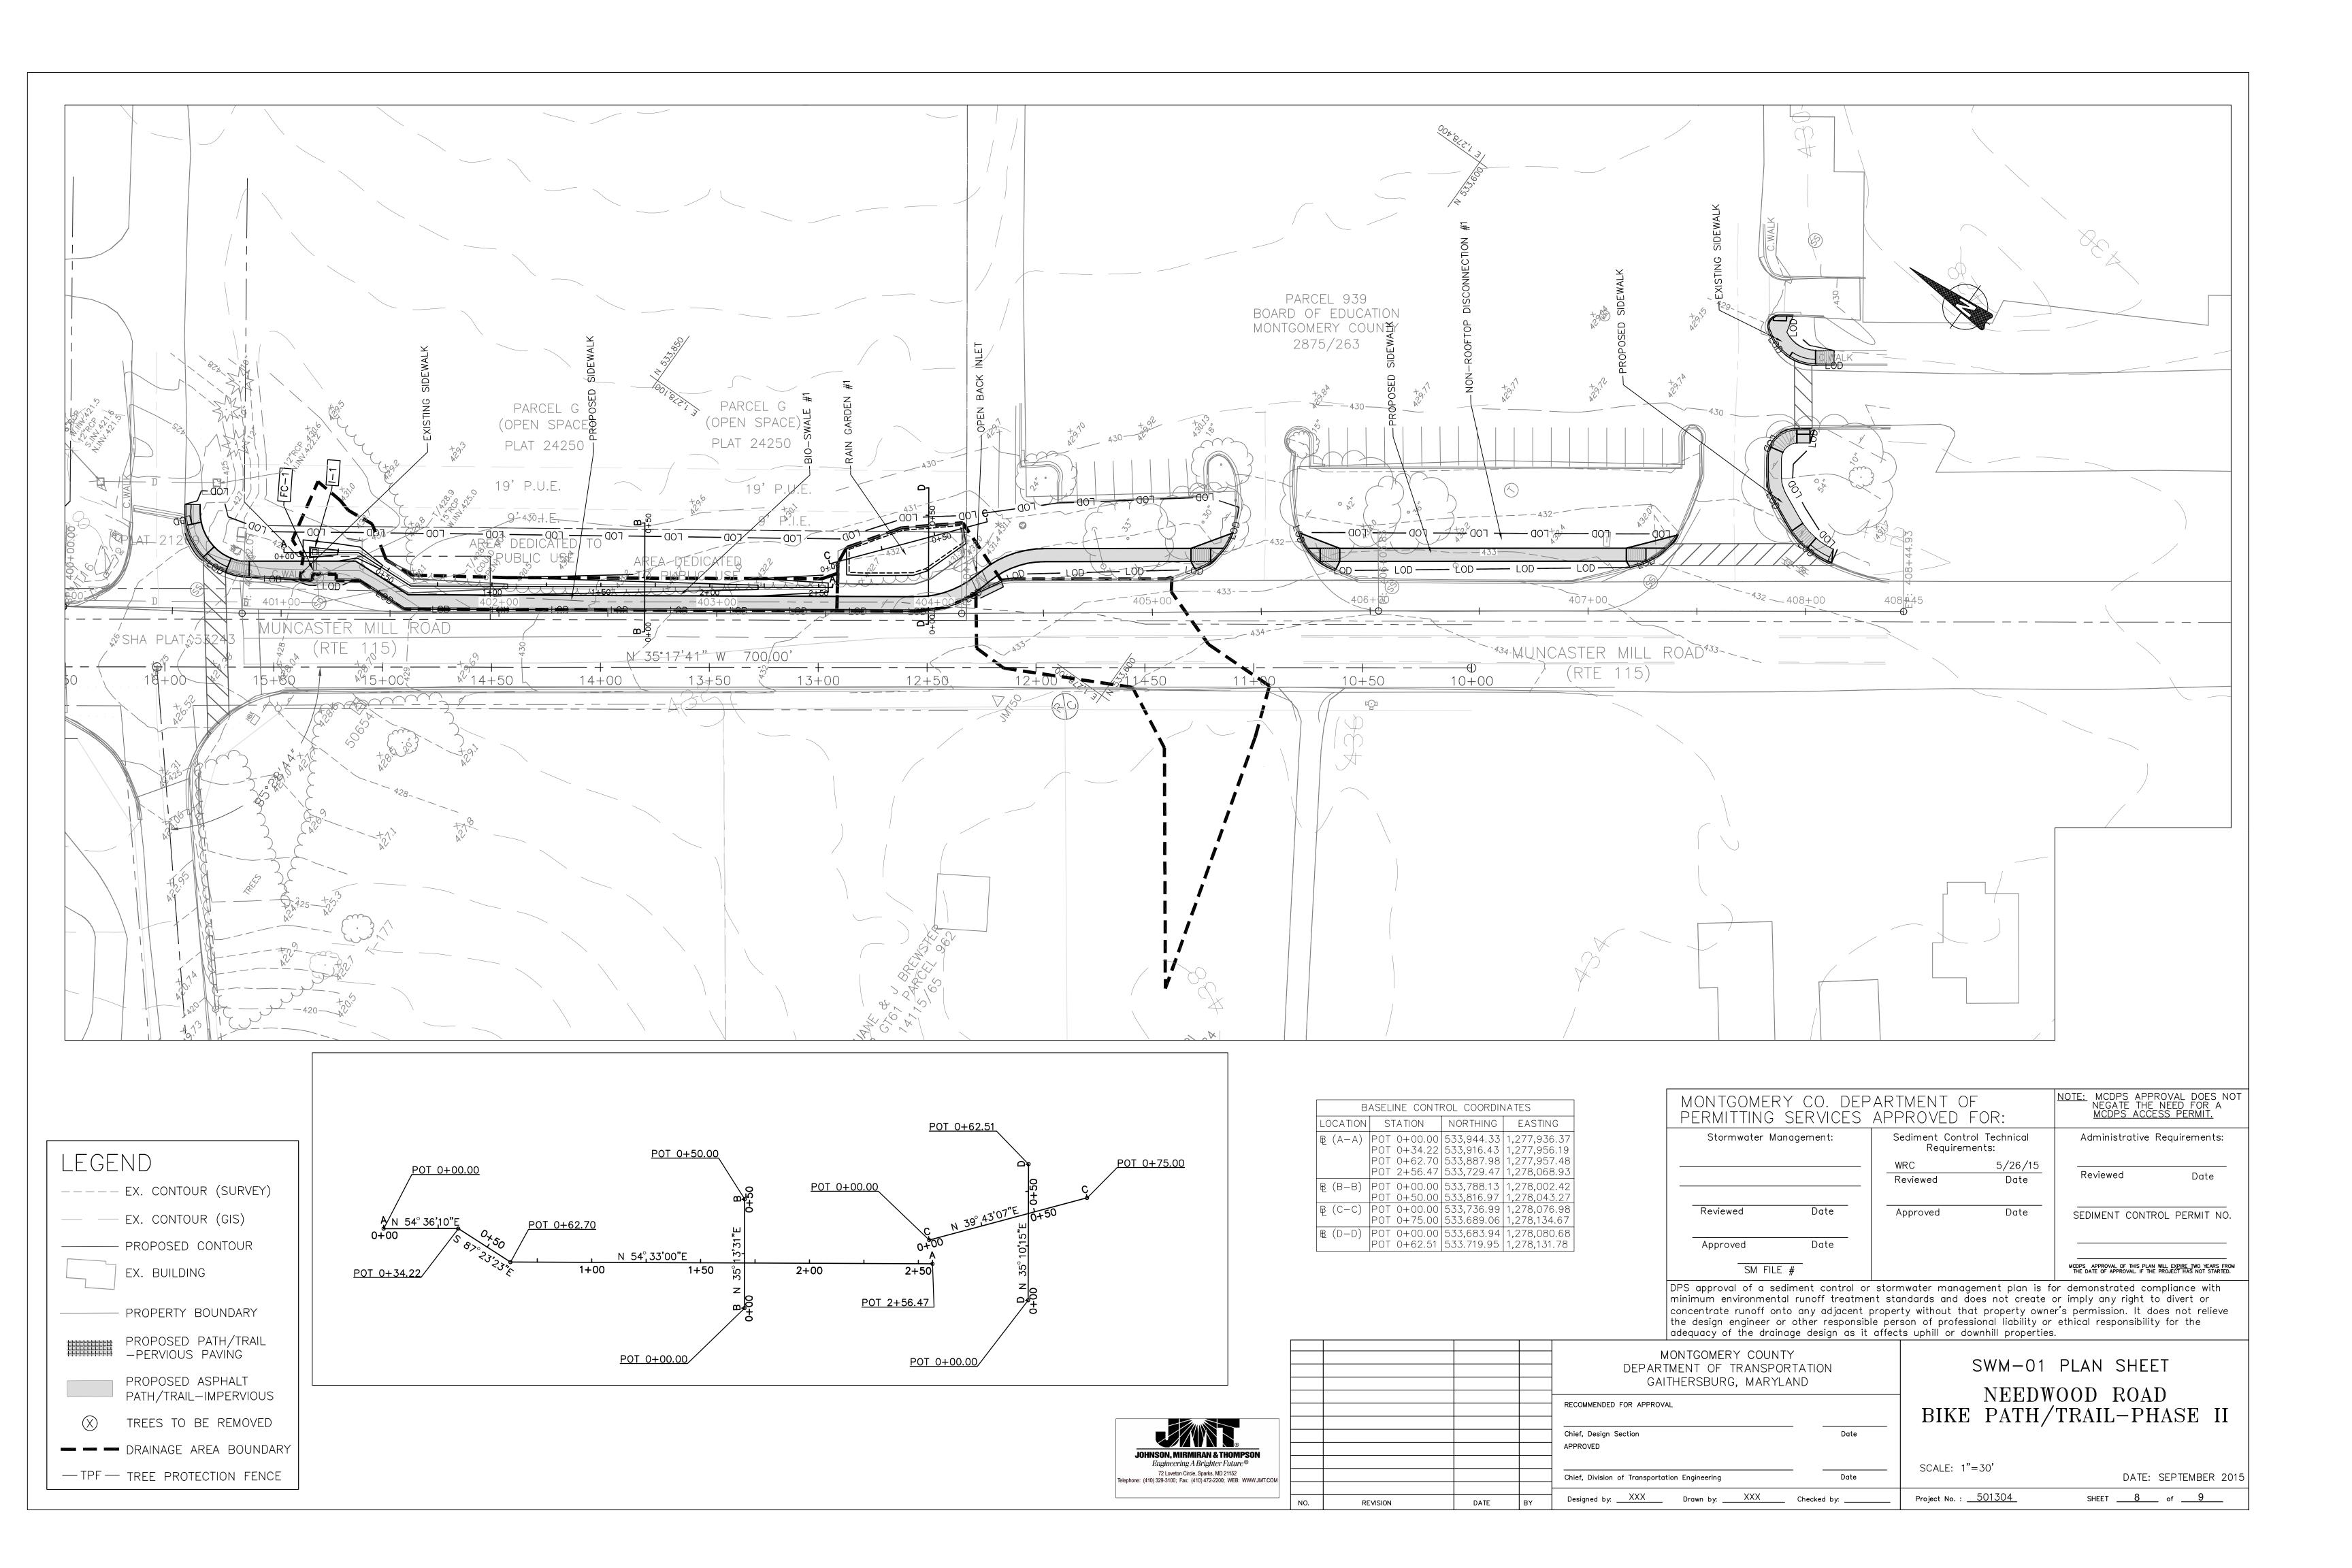

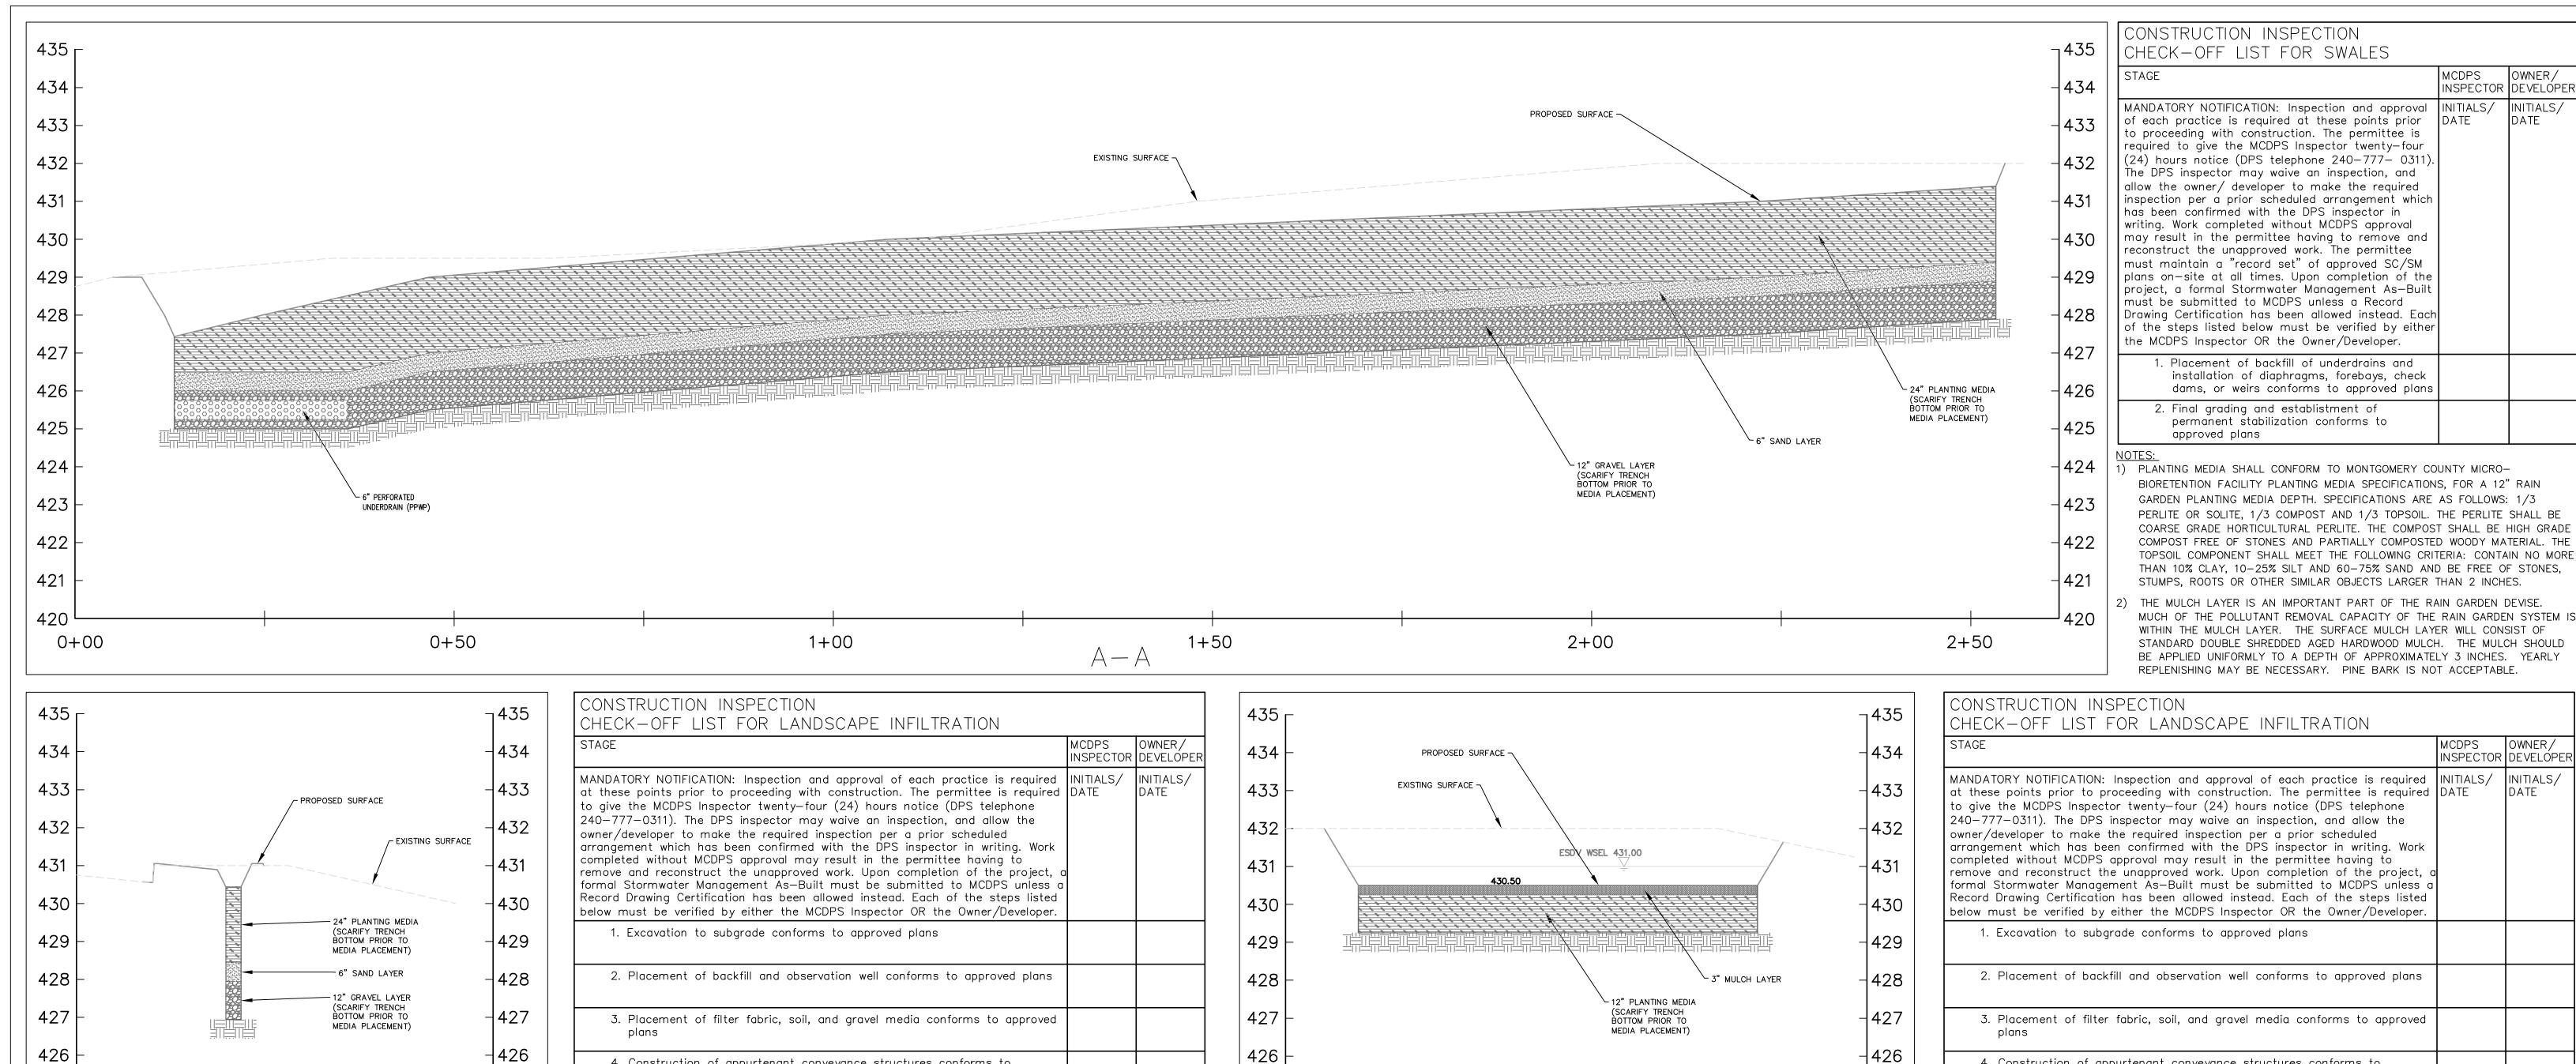

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435 [7435
434 -	EXISTING SURFACE \	434
433		- 433
432 -	PROPOSED SURFACE	- 432
431 -	430.50 431.00 3" MULCH LAYER	- 431
430 -	12" PLANTING MEDIA (SCARIFY TRENCH BOTTOM PRIOR TO	- 430
429 -	BOTTOM PRIOR TO MEDIA PLACEMENT)	429
428 -		- 428
427 -		- 427
426		-426
425		425
0+00	$\square - \square$ 0+50	

B-B

0+00

426

0 + 50

STAGE	MCDPS INSPECTOR	OWNER/ DEVELOPER
MANDATORY NOTIFICATION: Inspection and approval of each practice is required at these points prior to proceeding with construction. The permittee is required to give the MCDPS Inspector twenty—four (24) hours notice (DPS telephone 240—777—0311). The DPS inspector may waive an inspection, and allow the owner/developer to make the required inspection per a prior scheduled arrangement which has been confirmed with the DPS inspector in writing. Work completed without MCDPS approval may result in the permittee having to remove and reconstruct the unapproved work. Upon completion of the project, of formal Stormwater Management As—Built must be submitted to MCDPS unless a Record Drawing Certification has been allowed instead. Each of the steps listed below must be verified by either the MCDPS Inspector OR the Owner/Developer.	INITIALS/ DATE	INITIALS/ DATE
1. Excavation to subgrade conforms to approved plans		
2. Placement of backfill and observation well conforms to approved plans		
3. Placement of filter fabric, soil, and gravel media conforms to approved plans		
4. Construction of appurtenant conveyance structures conforms to approved plans		
5. Final grading and establistment of permanent stabilization conforms to approved plans		

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5. Final grading and establistment of permanent stabilization conforms to

approved plans

approved plans

STAGE	MCDPS INSPECTOR	OWNER/ DEVELOR
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2. Placement of backfill and observation well conforms to approved plans		
3. Placement of filter fabric, soil, and gravel media conforms to approved plans		
 Construction of appurtenant conveyance structures conforms to approved plans 		
Final grading and establistment of permanent stabilization conforms to approved plans		

MONTGOMERY CO. DEP PERMITTING SERVICES		•	NOTE: MCDPS APP NEGATE THE MCDPS ACCE	ROVAL DOES NOT NEED FOR A ESS PERMIT.
Stormwater Management:	Sediment Cont Requirer		Administrative	Requirements:
	WRC	5/26/15	Daviewed	
	Reviewed	Date	Reviewed	Date
Reviewed Date	Approved	Date	SEDIMENT CONTR	ROL PERMIT NO.
Approved Date				
SM FILE #			MCDPS APPROVAL OF THIS PLAN THE DATE OF APPROVAL. IF THE	WILL EX <u>PIRE T</u> WO YEARS FROM PROJECT HAS NOT STARTED.

|DPS approval of a sediment control or stormwater management plan is for demonstrated compliance with minimum environmental runoff treatment standards and does not create or imply any right to divert or concentrate runoff onto any adjacent property without that property owner's permission. It does not relieve the design engineer or other responsible person of professional liability or ethical responsibility for the adequacy of the drainage design as it affects uphill or downhill properties.

				MONTGOMERY COUNTY DEPARTMENT OF TRANSPOR GAITHERSBURG, MARYLAI	TATION		ETAIL SHEET
				RECOMMENDED FOR APPROVAL		1	OOD ROAD TRAIL-PHASE II
				Chief, Design Section APPROVED	Date	,	
				Chief, Division of Transportation Engineering	 Date	SCALE: 1"=30'	DATE: SEPTEMBER 2015
NO.	REVISION	DATE	BY	Designed by: XXX Drawn by: XXX	Checked by:	Project No. : <u>501304</u>	SHEET <u>9</u> of <u>9</u>

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